

City of Surrey PLANNING & DEVELOPMENT REPORT Application No.: 7921-0153-00

Planning Report Date: December 4, 2023


PROPOSAL:

- Development Permit
- Development Variance Permit

to permit the construction of a 20-storey mid-rise apartment building consisting of 175 dwelling units in Guildford. A variance is proposed to reduce the minimum on-site parking requirement and to increase the permitted lot coverage under the CD Zone.

LOCATION: 15200 Guildford Drive
ZONING: CD (Bylaw No. 17032)
OCP DESIGNATION: Multiple Residential

TCP DESIGNATION: Low Rise Transition Residential

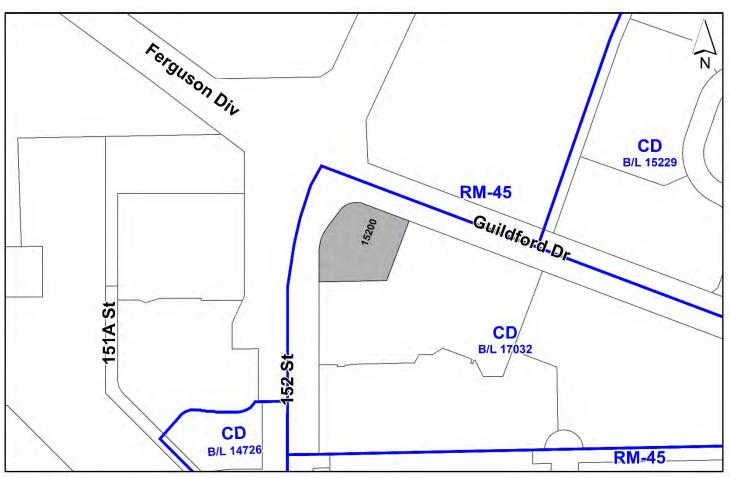

RECOMMENDATION SUMMARY

- Approval to draft Development Permit for Form and Character.
- Approval for Development Variance Permit to proceed to Public Notification.

DEVIATION FROM PLANS, POLICIES OR REGULATIONS

- Proposal to reduce the minimum parking requirement on-site, under the Zoning Bylaw, to reflect the parking rates supported by Council for Rapid Transit Areas (RTAs).
- Proposed variance to increase the maximum permitted lot coverage under the CD Bylaw.

RATIONALE OF RECOMMENDATION

- The proposal complies with the Development Permit guidelines in the OCP for Form and Character.
- The proposed building achieves an attractive built form which utilizes high quality materials and contemporary lines. The street interface has been designed to achieve a positive urban experience between the proposed building and the public realm.
- The proposed variance to reduce the minimum on-site parking requirement is supported by staff given the proposed parking rate reduction is consistent with the parking rate previously supported by Council for similar developments located within a Rapid Transit Area (RTA).
- The applicant is requesting a 2% increase in the maximum allowable lot coverage on the subject site, under the CD Zone, in order to accommodate the proposed building footprint.

RECOMMENDATION

The Planning & Development Department recommends that:

- 1. Council authorize staff to draft Development Permit No. 7921-0153-00 generally in accordance with the attached drawings (Appendix I).
- 2. Council approve Development Variance Permit No. 7921-0153-00 (Appendix V) varying the following, to proceed to Public Notification:
 - (a) to reduce the minimum on-site parking requirement for non-ground oriented multiple unit residential dwellings to 1.1 parking space per dwelling unit for residents and 0.1 parking space per dwelling unit for visitors; and
 - (b) to vary the maximum permitted lot coverage under CD Bylaw No. 17032 from 40% to 42%.
- 3. Council instruct staff to resolve the following issues prior to final approval:
 - (a) ensure that all engineering requirements and issues including restrictive covenants, dedications, and rights-of-way where necessary, are addressed to the satisfaction of the General Manager, Engineering;
 - (b) approval and input from the Ministry of Transportation & Infrastructure;
 - (c) resolution of all urban design issues to the satisfaction of the Planning and Development Department;
 - (d) submission of a finalized landscaping plan and landscaping cost estimate to the specifications and satisfaction of the Planning and Development Department;
 - (e) submission of a finalized tree survey and a statement regarding tree preservation to the satisfaction of the City Landscape Architect;
 - (f) the applicant satisfy the deficiency in tree replacement on the site, to the satisfaction of the Planning and Development Department;
 - (g) discharge the Restrictive Covenant (No Build) registered on title (CA2287218); and
 - (h) submission of an acoustical report for the units adjacent to 152 Street and registration of a Section 219 Restrictive Covenant to ensure implementation of noise mitigation measures.

SITE CONTEXT & BACKGROUND

Direction	Existing Use	OCP/TCP	Existing Zone
	-	Designation	
Subject Site	Vacant parcel	Multiple	CD (Bylaw No.
		Residential	17032)
North	Townhouse development	Multiple	RM-45
(Across Guildford Drive):	(Guildford Close)	Residential	
East and South:	Low-rise apartment	Multiple	CD (Bylaw No.
	buildings (Boulevard	Residential	17032)
	Club)		
West	Low-rise apartment	Multiple	RM-45
(Across 152 Street):	buildings (Lincoln's Hill)	Residential/Low	
		Rise Transition	
		Residential	

Context & Background

- The subject site, located at 15200 Guildford Drive, is approximately 0.29 hectare in area.
- The site is designated "Multiple Residential" in the Official Community Plan (OCP), "Low Rise Transition Residential" in the Guildford Plan (TCP) and zoned "Comprehensive Development Zone (CD)" (Bylaw No. 17032).
- The subject property is the last phase in a multi-phase project that included the following:
 - o Development Application Nos. 5694-0138-00 (Rezoning) and 6794-0138-00 (DP)
 - Rezoning to "Comprehensive Development Zone (CD)" and Development Permit (DP) for seven 4-storey apartment buildings and one 18-storey high-rise apartment building, located on the subject site.
 - The original proposal was for an 8-phase multiple residential development. Two 4-storey apartment buildings were constructed in earlier phases on the northern portion of the site while a presentation centre was constructed for the sale of the residential units proposed at the "Boulevard Club", located at 15210/15220 Guildford Drive, on the subject site where the applicant originally proposed the 18-storey high-rise building.
 - The sales centre was subsequently removed from the subject site, which has remained vacant.
 - o Development Application No. 7909-0060-00
 - Rezoning from CD to CD to allow for an alternate subdivision pattern and to remove some of the restrictions in the original CD Bylaw (e.g. replace the maximum number of dwelling units permitted with a maximum Floor Area Ratio [FAR]).
 - These changes were intended to put in place a development framework that could facilitate development on the remainder of the original parent parcel.
 - o Development Application No. 7913-0230-00

• The application involved a Development Permit and Development Variance Permit to construct a total of 170 three-storey ground-oriented townhouses (called "Guildford the Great") on the southern and eastern portion of the original development site. The townhouse units have been fully constructed.

DEVELOPMENT PROPOSAL

Planning Considerations

- The applicant proposes a Detailed Development Permit (DP) to allow for the construction of one 20-storey mid-rise apartment building consisting of 175 dwelling units with underground parking. A variance is required in order to reduce the minimum parking requirement on-site from 279 stalls to 235 stalls.
- Specific details on the development proposal are provided in the table below:

	Proposed
Lot Area	
Gross Site Area:	2,887.7 square metres
Road Dedication:	N/A
Undevelopable Area:	N/A
Net Site Area:	2,887.7 square metres
Number of Lots:	ı (existing)
Building Height:	61 metres
Unit Density:	N/A
Floor Area Ratio (FAR):	4.49
Floor Area	
Residential:	10,908.92 square metres
Commercial:	N/A
Total:	10,908.92 square metres
Residential Units:	
ı-Bedroom:	20 dwelling units
1-Bedroom plus den:	74 dwelling units
2-Bedroom:	68 dwelling units
2-Bedroom plus den:	2 dwelling units
3-Bedroom:	2 dwelling units
3-Bedroom plus den:	9 dwelling units
Adaptable units:	16 dwelling units
Total:	175 dwelling units

Referrals

Engineering: The Engineering Department has no objection to the project subject

to the completion of Engineering servicing requirements as outlined $% \left(1\right) =\left(1\right) \left(1\right)$

in Appendix II.

School District: The School District has advised that there will be approximately 7

school-age children generated by this development, of which the School District has provided the following expected student

enrollment.

4 Elementary students at Harold Bishop Elementary School

2 Secondary students at Johnston Heights Secondary School

(Appendix III)

Note that the number of school-age children is greater than the expected enrollment due to students attending private schools,

home school or different school districts.

The applicant has advised that the dwelling units in this project are

expected to be constructed and ready for occupancy by Winter,

2027.

Parks, Recreation & Culture:

No concerns.

The closest active park is Guildford Recreation Centre Skate Park which is 450 metres walking distance and the closest natural area is Ocean Estates Park which is 900 metres walking distance from the development. Future parkland is proposed within 850 metres walking distance of the subject site, as part of the Guildford Plan.

Ministry of Transportation & Infrastructure (MOTI):

No concerns.

Surrey Fire Department: No concerns.

Advisory Design Panel: The proposal was considered at the ADP meeting on October 26,

and was supported. The applicant has agreed to resolve the key issues from the ADP review, as outlined in the Development Permit section of this report. Any additional revisions will be completed prior to Council's consideration of Final Adoption of the rezoning by-law, to the satisfaction of the Planning and

Development Department.

Transportation Considerations

- The proposed apartment building will have an underground parkade accessed via a shared driveway with the existing southerly and easterly strata developments (Boulevard Club and Guildford the Great). An easement for shared driveway access was registered on title, as part of Development Application No. 7994-0138-00, in order to secure this shared driveway access arrangement.
- The subject property is located within approximately 440 metres of an existing bus stop (#335 Newton Exchange to Surrey Central Station and #341 Newton Exchange to Guildford).
- The Ministry of Transportation and Infrastructure (MOTI) maintains jurisdiction over this portion of 152 Street (until Lincoln Drive). As such, MOTI is required to provide input and approval for the proposed development.
- According to industry standard rates, the subject site is anticipated to generate approximately
 one to two vehicles every minute in the peak hour. The applicant was not required to provide
 a transportation impact analysis ("TIA") as the number of site-generated trips is below the
 City's threshold. In addition, an area-wide TIA has been conducted as part of the Guildford
 Plan, which was a comprehensive evaluation of traffic impacts of development of the Plan area
 and informed the Plan area servicing strategy.

Sustainability Considerations

• The applicant has met all of the typical sustainable development criteria, as indicated in the Sustainable Development Checklist.

POLICY & BY-LAW CONSIDERATIONS

Regional Growth Strategy

- The subject property is designated General Urban in the Regional Growth Strategy (RGS).
- The proposed development complies with the General Urban RGS designation.

Official Community Plan

Land Use Designation

- The subject property is designated Multiple Residential in the Official Community Plan (OCP).
- Although the density of the proposed development on the subject site exceeds the allowable
 density under the Multiple Residential OCP designation, no OCP Amendment is proposed or
 required given the subject site was previously zoned to permit the current form, building
 height and overall density. No rezoning is required.

Themes/Policies

- The development proposal supports transit-oriented development, focused growth and increased density within close proximity to transit corridors (152 Street and 104 Avenue), which supports transit service expansion and rapid transit infrastructure investment.
- The proposal supports directing higher-density residential land uses to locations within
 walking distance of neighbourhood centres, along main roads, near transit routes and/or
 within close proximity to major parks or civic amenities.
- The dwelling units front onto Guildford Drive and 152 Street with urban design features (e.g. ground-floor patio space, upper-storey balconies, internal sidewalks, etc.) that promote a welcoming public streetscape and urban public realm.

Secondary Plans

Land Use Designation

- The subject property is designated "Low Rise Transition Residential" in the Guildford Plan (TCP).
- Although the proposal does not comply with the existing land-use designation, no TCP Amendment is proposed or required given the subject site was previously zoned to permit the current form, building height and overall density. No rezoning is required.

Themes/Objectives

- The Guildford Plan includes a number of family-oriented and affordable housing policies intended to encourage a greater diversity of housing options for different family sizes, types and compositions. These policies include providing a minimum of thirty percent (30%) of all new dwelling units as two or more bedroom and ten percent (10%) of all new units as three or more bedroom.
- Staff note that the proposal partially complies with the family-oriented housing policies in the Town Centre Plan (TCP) by providing approximately forty-six percent (46%) of the dwelling units as two or more bedroom (81 dwelling units in total) and six percent (6%) of the dwelling units as three or more bedroom (11 units in total).

CD Bylaw No. 17032

- The subject property is regulated by a "Comprehensive Development Zone (CD)" (Bylaw No. 17032). The CD Zone allows for a high-rise multiple residential development on the site. The current proposal complies with all aspects of the CD Bylaw, with the exception of the on-site parking requirement and maximum permitted lot coverage which will be addressed through a Development Variance Permit (DVP).
- A comparison of the CD Zone (Bylaw No. 17032) and the current proposal is provided in the table below:

Zoning	CD Zone (Bylaw No. 17032)	Current Proposal
Unit Density:	N/A	N/A
Floor Area Ratio:	4.5	4.49
Lot Coverage:	40%	42%
Yards and Setbacks		
North Yard	7.5 m.	7.5 m.
East Yard	1.52 m.	1.52 m.
South Yard	1.52 m.	1.52 m.
West Yard	7.5 m.	7.5 m.
Principal Building Height:	61 m.	61 m.
Permitted Uses:	Multiple unit residential	Multiple unit residential
	buildings, ground-oriented	buildings, ground-oriented
	multiple unit residential	multiple unit residential
	buildings and child	buildings and child
	care centres	care centres
Amenity Space		
Indoor Amenity:	525 sq. m.	The proposed 532 m²
		exceeds the CD Bylaw
		requirement
Outdoor Amenity:	525 sq. m.	
		The proposed 552 m²
		exceeds the CD Bylaw
		requirement
Parking (Part 5)	Required	Proposed
Number of Stalls		
Residential:	244 parking spaces	213 parking spaces
Residential Visitor:	35 parking spaces	20 parking spaces
Total:	279 parking spaces	233 parking spaces
Bicycle Spaces		
Residential Secure Parking:	210 bicycle spaces	218 bicycle spaces
Residential Visitor:	6 bicycle spaces	6 bicycle spaces

Proposed Variances

- The applicant is requesting a variance to reduce the minimum on-site parking requirement, under the Zoning Bylaw, from 279 parking spaces to 233 parking spaces.
- Under the Zoning Bylaw, a total of 279 parking spaces are required based upon 1.3 parking space per dwelling unit for one bedroom units, 1.5 parking space per dwelling unit for 2 or more bedroom units and 0.2 parking space per dwelling unit for visitors.
- The applicant is proposing to provide a rate of 1.1 parking space per dwelling unit for residents and 0.1 parking space per dwelling unit for visitors (1.2 per unit in total). The proposed parking reduction is supportable given the subject site is located within a Rapid Transit Area (RTA) and complies with the reduced parking rates, previously endorsed by Council, as part of Corporate Report No. R115;2021 ("Parking Update: Rapid Transit Corridors and Rental Housing").

- The applicant further proposes to vary the maximum permitted lot coverage, under CD Bylaw No. 17032, from 40% to 42% in order to accommodate the proposed built form.
- The proposed variance is supportable given that it is only a slight increase over the current maximum permitted lot coverage, under the CD Zone, and typical for a high-rise building on a site of this size.
- Staff support the requested variances to proceed for consideration.

Capital Projects Community Amenity Contributions (CACs)

- On December 16, 2019, Council approved the City's Community Amenity Contribution and Density Bonus Program Update (Corporate Report No. R224; 2019). The intent of that report was to introduce a new City-wide Community Amenity Contribution (CAC) and updated Density Bonus Policy to offset the impacts of growth from development and to provide additional funding for community capital projects identified in the City's Annual Five-Year Capital Financial Plan. A fee update has been approved in April 2023, under Corporate Report No.R037;2023.
- The proposed development will be subject to the Tier 1 Capital Plan Project CACs. The contribution will be payable at the rate applicable at the time of Final Subdivision Approval. The current rate is \$2,136 per new unit.
- The proposed development will not be subject to the Tier 2 Capital Plan Project CACs given the subject site is already zoned to permit the current form, building height and overall density.

PUBLIC ENGAGEMENT

• The Development Proposal Signs were installed on November 18, 2023. To date, staff have not received any responses from adjacent residents or the general public regarding the development proposal.

DEVELOPMENT PERMITS

Form and Character Development Permit Requirement

- The proposed development is subject to a Development Permit for Form and Character and is subject to the urban design guidelines outlined within the OCP and the Guildford Plan.
- The proposal generally complies with the Form and Character Development Permit guidelines in the OCP and Guildford Plan.
- The applicant has worked with staff to ensure an appropriate interface between land-uses and to refine the overall building massing to ensure an attractive streetscape that reflects an urban public realm.

Building Design

- The proposed development includes a 20-storey residential high-rise building with threestorey townhouse units at-grade and consists of 175 market dwelling units with underground parking.
- The proposed building façade reflects a contemporary and dynamic built form with particular attention provided to tower placement, building orientation, and balcony design, reflecting the alignments of the adjacent roads. The upper levels of the tower height taper to create a distinct tower top on the skyline.
- The at-grade townhouse units are designed to wrap around the frontage, separated by a generous setback, accommodating an outdoor amenity space at the intersection of 152 Street and Guildford Drive. The tower features a centralized residential lobby anchored at the northwest corner of the site.
- The street interface was carefully designed to maintain a connection with the public realm while providing a comfortable pedestrian experience for visitors to the building. The landscape treatment at the corner creates a visual screen for the residents from the busy intersection.
- The proposed building materials include architectural concrete, a window wall system with insulated aluminum panels, clear glass, low-E glass as well as spandrel glass in prefinished aluminum frames, prefinished metal doors, fiberglass doors with wood grain texture for the at-grade townhouse units and metal canopies with frosted safety glass.
- The proposed building form adopts a modern architectural vocabulary that, while distinctive, is compatible with the current high-rise typology in Surrey's town centres.

Proposed Signage

- The applicant is proposing one identification sign along the northern building elevation, just outside the principal lobby entrance. The proposed sign is comprised of architectural coated concrete with pin-mounted brushed aluminum numbers/letters and roughly 1 metre in height.
- Individual unit addresses will be provided outside the private entrance gate, mounted on the architectural coated concrete wall, for each at-grade townhouse unit to assist in wayfinding.
- The proposed signage on-site complies with all aspects of the Surrey Sign By-law including the total sign height, sign area and minimum setback requirement.

Indoor Amenity Space

- The proposed indoor amenity space is centrally located at-grade and on Level 2 This location provides for greater connectivity between the indoor and adjacent outdoor amenity spaces.
- The indoor amenity space consists of a dining area, game room and lounge/business area on the ground-floor with a yoga studio, gym and steam room on Level 2.

• Based upon the CD Zone (Bylaw No. 17032), the proposed development is required to provide 525 square metres of indoor amenity space. The proposed indoor amenity space is 532 square metres in total area which exceeds the minimum requirement in the CD Zone.

Outdoor Amenity Space and Proposed Landscaping

- The outdoor amenity space is centrally located and adjacent to the indoor amenity space.
- The applicant is proposing to provide the following outdoor amenity space:
 - o Level 1: 472.05 square metres; and
 - o Level 2: 60.23 square metres.
- The proposed outdoor amenity space is 552 square metres in total area which exceeds the minimum outdoor amenity space requirement, per the CD Bylaw, based upon a total of 3 square metres per dwelling unit.
- The outdoor amenity space will consist of a putting green, dog off-leash area, children's playground equipment, urban agricultural area, outdoor kitchen and dining area, lounge furniture and bench seating at-grade with an outdoor amenity deck on Level 2.
- The proposed landscaping has been designed to respond to the urban nature of Guildford Town Centre as an active, pedestrian-friendly space. The overall design considers site circulation and grade change and incorporates an inclusive interface between the public and private realm.
- Each individual ground-oriented townhouse unit will have a small private patio enclosed by a privacy hedge and low-level metal picket fence with layered planting that consists of a by-law sized tree, small shrubs and low-lying groundcover.
- The at-grade townhouse units and penthouse apartments on Level 20 will have access to private rooftop amenity space.
- Exterior lighting will be designed to reduce light pollution as well as provide adequate lighting to ensure community safety, in keeping with CPTED principles.

Advisory Design Panel

ADP date: October 26, 2023

The applicant has agreed to resolve the remaining outstanding items noted below, to the satisfaction of the Planning and Development Department, before Final Adoption (Appendix VI).

Outstanding Items

- The applicant is required to resolve all outstanding urban design and landscaping issues and Advisory Design Panel comments, as follows:
 - o Design development to the architectural material scheme;
 - o Refinement to the site interfaces; and
 - o Review of the amenity function.
- The applicant has been provided with a list identifying these requirements and has agreed to resolve these issues prior to Final Approval of the Development Permit, should the application be supported by Council.

TREES

• Stuart Goode, ISA Certified Arborist of Goode Arboriculture Consulting prepared an Arborist Assessment for the subject property. The table below provides a summary of the proposed tree retention and removal by tree species:

Table 1: Summary of Proposed Tree Preservation by Tree Species:

Tree Species	Ex	isting	Remove	Retain
	Alde	er Trees		
Alder		2	2	0
((ous Trees g Alder Trees	s)	
Red Maple		3	1	2
Red Oak		1	0	1
	Conife	rous Trees		
Western Red Cedar		4	3	1
Spruce		1	1	0
Total (excluding Alder Trees)		9	5	4
Total Replacement Trees Proposed (excluding Boulevard Street Trees)	l		48	
Total Retained and Replacement T Proposed	rees		52	
Estimated Contribution to the Gre Program	en City		N/A	

• The Arborist Assessment states that there are a total of nine (9) mature trees on the site, excluding Alder trees. Two (2) existing trees, approximately eighteen percent (18%) of the total trees on the site, are Alder trees. The applicant proposes to retain four (4) trees as part of this development proposal. The proposed tree retention was assessed taking into consideration the location of services, building footprints, road dedication and proposed lot grading.

- For those trees that cannot be retained, the applicant will be required to plant trees on a 1 to 1 replacement ratio for Alder and Cottonwood trees and a 2 to 1 replacement ratio for all other trees. This will require a proposed total of twenty (20) replacement trees on the site. The applicant is proposing forty-eight (48) replacement trees, thereby exceeding City requirements.
- In addition to the replacement trees, boulevard street trees will be planted on Guildford Drive and 152 Street. This will be determined by the Engineering Department during the servicing design review process.
- The new trees on the site will consist of a variety of trees including Katsura, White Wonder Dogwood, Starlight Dogwood, Tulip Tree, Kobus Magnolia, Red Oak, Columnar European Aspen, Red Oak, Japanese Stewartia and Japanese Snowbell.
- In summary, a total of fifty-two (52) trees are proposed to be retained or replaced on the site with no contribution required to the Green City Program.
- The proposed tree retention and replacement strategy will be refined as the applicant works through the detailed design process.

INFORMATION ATTACHED TO THIS REPORT

The following information is attached to this Report:

Appendix I. Site Plan, Building Elevation Drawings, Landscape Plans and Perspective

Appendix II. Engineering Summary
Appendix III. School District Comments

Appendix IV. Summary of Tree Survey, Tree Preservation and Tree Plans

Appendix V. Development Variance Permit No. 7921-0153-00

Appendix VI. ADP Comments and Response

approved by Ron Gill

Don Luymes General Manager Planning and Development

MJ/ar

Appendix I



15200 GUILDFORD DRIVE SURREY, BC







PROJECT DATA

PROJECT SUMMARY:

CIVIC ADDRESS: 15200 GUILDFORD DRIVE, SURREY, B.C.

*LEGAL ADDRESS: LOT C SEC 21 BLOCK 5 NORTH RANGE 1 WEST NWD PLAN LMP27911

OWNER: SOLTERRA (GUIDFORD 2) LIMITED PARTNERSHIP

AUTHORITY HAVING JURISDICTION: CITY OF SURREY, B.C.

ZONING OVERVIEW: PERMITTED PROPOSED

ZONING: CD: (BYLAW NO. 17032) CD: (BYLAW NO. 17032)

SETBACKS:

FRONT (NORTH) 7.50 m 7.50 m

REAR (SOUTH) 1.52 m 1.52 m

INTERIOR SIDE (EAST) 1.52 m

EXTERIOR SIDE (WEST) 7.50 m 7.50 m

BUILDING HEIGHT: 61 m 60.83 m

SITE AREA: 2,887.70 m2

 SITE COVERAGE:
 40%
 42% (1,223.54 m2)

 TOTAL FLOOR AREA:
 n/a
 12,965.86 m2

FLOOR SPACE RATIO: 4.50 4.49

BUILDING AREA OVERVIEW:

 NET RESIDENTIAL:
 10,908.92 m2

 INDOOR AMENITIES:
 REQUIRED: 525 m2
 PROVIDED: 532.36 m2

 OUTDOOR AMENITIES:
 REQUIRED: 525 m2
 PROVIDED: 552.09 m2

TOTAL NUMBER OF UNITS: 175 NUMBER OF ADAPTABLE UNITS: 16 (9.1%)

PARKING OVERVIEW:

VEHICLE PARKING REQUIREMENTS:

VEHICLE I ARRIVE	IO NEGOINEMENTO	•		
LOADI OFF-S	NG TREET	REQUIRED (ZONING) NO REQUIREMENT	REQUIRED (CD:RM-70	0) PROVIDED 1
	TMENTS	MIN. 1.1 PER UNIT = 1.1 x 175 = MAX. 1.3 PER UNIT = 1.3 x 175 =	193 228	217
VISITO	ORS/ CARPOOLS	0.1 PER UNIT = 0.1 x 175 =	18	18
TOTAL	=		211 TO 246	235
ACCES	SSIBLE SPACE	2% OF TOTAL SPACES	5	5
PROPOSED VEHI	ICLE PARKING:	REGULAR CAR STALL	SMALL CAR STALL	ACCESSIBLE STALL
P5 5	54	52	2	0
P4 5	54	52	2	0
P3 5	53	51	2	0
	52	46	2	4
P1 2	22	19	2	1
23	35	220 (96%)	10 (4%)	5
BICYCLE STORAG	GE REQUIREMENT	3:		
RESIDENTIA		SS "A" : 1.2 PER UNIT = 210 SS "B" SPACES = 6 SPACES	210 6	218 6

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shall verify and be responsible for all dimensions
and conditions on the bid and this office shall be
informed of any variations from the dimensions and
conditions shown on the disease.

Drawing Issue Date

Revision Schedule

Rev#	Date	Description
1	JUN 02-2021	ISSUED FOR DP
2	DECEMBER-2022	RE-ISSUED FOR DP
3	SEPTEMBER-2023	RE-ISSUED FOR DP
4	OCTOBER-2023	DE ISSUED EOD DD





15200 GUILDFORD DRIVE

Drawing Title
PROJECT DATA

Date:	Project No.
NOVEMBER - 2023	19-63
Scale	Drawing No.
1:1	40.00
Drawn By:	A0-03
TG / HR	

PROJECT STATISTIC

15200 GUILDFORD DR. SURREY

AREA CALCULATION

									EXCU	JSIONS												_
	FLOOR	FLOOR TO	FLOOR	GROSS A	AREA	AME	NITY	SERVICE / G	ARBAGE	WALL EXC	LUSION	EXCLUSION S	SUB TOTAL	LOBBY & MAII	ROOM	NET ARE	A (FAR)	CIRCULATIONS I	6 COMMON	RES. SALABI	E AREA	EFFICIENCY
-	T. Carolii	mm	ft.	SOM	SKIF	SOM	SQF	SOM	SOF	SOM	SKIF	SQM	SOF	SOM	SOF	SQM	SCIE	SOM	SQF	SQM	SQF	Eliterate.
TOP ROOF												-										
ROOF & ME	CH.	3150	10.33	113.61	1,222.89		- 1	88,03	984 49			24.03	504.49			74 58	318.40	29.58	318:40	0.00	0.00	0,00
EVEL 21	[L20	3226	10.58	451,29	4,857.65					8.81	73.30	6.81	73.50			444.48	4,784.34	79.25	853.04	372.04	4,004.61	82,44
EVEL 20	(L19	3023	9.92	513.46	5,576.84					7.66	.79.72	7.36	29.77			506.10	5,447.62	82.06	283.79	431.40	4,641.55	84.02
EVEL 19	(L18	3023	9.92	513.26	5,524.68					5.33	61.57	5.72	61.57			507.54	5,463.12	82.74	890.61	430.52	4,634,08	83.88
LEVEL 18	(t.17	3023	9.92	524.31	5,643.63				- 1	5.77	61.57	5,72	61,57			518.59	5,582.06	82.74	890.61	441.57	4,753 02	84.22
EVEL 17	(L16	3023	9.92	655.81	7,059.08					5.95	100.04	9.35	100,64			646.46	6,958.44	98,56	1,050.89	557.25	5,998.19	84.97
EVEL 16	(115	2845	9.33	655-81	7,059.08					9.15	100.64	9.35	100.64			546.46	5,958.44	98.56	1,060.89	557.25	5,998.19	84.97
EVEL 15	(1.14	2845	9.33	655.81	7,059.08					9.15	100.64	9.35	300.64			646.46	6,958.44	98.56	1,080.89	557.25	5,998.19	84.97
LEVEL 14	(t.13	2845	9.33	655.81	7,059.08					5.35	2,00,64	9.35	300.64			646.46	6,958.44	98.56	1,060.89	557.25	5,998.19	84,97
EVEL 13	(L12	2845	9.33	855.81	7,059.08					9.11	100.64	8.35	100.64			646.46	6,958,44	98.56	1,090.89	557.25	5,998.19	84.97
EVEL 12	(LIL	2845	9.33	655.81	7,059.08					9.85	100.64	9.35	100.64			646.46	6.958.44	98.56	1.060.89	557.25	5,998 19	84.97
LEVEL 11	(L10	2845	9.33	655.81	7,059.08					9.15	100.64	9.35	000.64			645.46	6,958.44	58.56	1,060.89	557.25	5,992.19	84.97
EVEL 10	(1.9	2845	9.33	655.81	7,059.08				- 11	9.35	- 200 64	9.35	200 64			646.46	6,958.44	98.56	1,060.89	557.25	5,998.19	84,97
EVEL 9	(18	2845	9.33	655.81	7,059.08					.5.5%	1,00,64	9,35	100,64			646.46	6,958.44	98.56	1,050.89	557,25	5,998.19	84.97
EVEL 8	(L7	2845	9.33	655-81	7,059.08					9.15	100.64	9.35	100.64			fi46.4ti	6,958.44	98.56	1,060.89	557.25	5,998.19	84.97
EVEL 7	(L6	2845	9.33	655.81	7,059.08					9.35	100.64	9.35	100.64			646.46	5,958.44	98.56	1,060.89	557:25	5,998.19	84.97
LEVEL 6	(1.5	2845	9.33	655.81	7,059.08			1		# 19	2,00.64	9,35	2,00,64			646,46	6,958.44	98.56	1,060.89	557.25	5,998.19	84,97
EVEL 5	(L4	2845	9.33	895.81	7,059.08					9.13	100.64	8.85	100.64			646.46	6,958.44	98.56	1,050.89	557.25	5,998.19	84,97
EVEL 4	(L3	2845	9.33	655.81	7,059.08					9.45	100.64	9-35	100.64			646.46	6,958,44	98.56	1.060.89	557.25	5.998 19	84.97
EVEL 3	(L2 TOWER	2845	9.33	829,77	8,931.57					13.89	257.04	23.68	257.04			805.89	8,674.53	98.55	1,060.78	731.22	7,670,79	88.12
EVEL 2	(CI TOWNHOUSE)	2845	9.33	721.30	7,764.01	7.85.53	3,071.42	4		1117	133.15	297.90	3,206,37			423.40	4,557.44	83.61	902.12	351.96	3,788.47	48,80
EVEL 1		2845	9.33	967,83	10,417.64	246.83	2,656.86			LLA2	133.06	259.25	2,750.54	193.59	2,083.79	708.58	7,627,09	341.27	3,673,40	379.73	4,087.38	29,24
TOTAL		60838	199.60	13.816.17	148:716.02	(5.82.86)	5.710.26	89.03	904.49	70% 18	2 206 54	822.57	1 843 11	193 59	2.083.79	12.994.60	139 872 71	7.259.84	24,324,72	10.919.94	117.756.55	

TOTAL BUILDING AREA (GROSS)		13,816.17 sq Meter	148,716.02 sqf
TOTAL EXCLUSIONS		821.57 sq Meter	8,843.31 sqf
TOTAL FAR AREA (NET)		12,994.60 sq Meter	139,872.71 sqf
	AMENITY	532,36 sqm	5,730.28 sqf
EXCLUSIONS	OUTDOOR AMENITY	552.09 sqm	5,942,65 sqf
	EXT. WALLEXEMPTION	205,18 sgm	2,208.54 suf

				Ut	HT TYPE					N OF UNITS PE
FLOOR	STUDIO	STUDIO+DEN	160 REG.	1BR AD	18R+DEN	288	2BR+DEN	388	BER+DEN	FLOOR
TOP ROOF										
ROOF & MECH										
LEVEL 20 (PENTHOLISE)						2		1		1
LEVEL 19 (SUB-PENTHOUSE)			77.7	-		4				4
LEVEL 18			2			2			- 2	6
LEVEL 17			2		100	2			2	- 6
LEVEL 16					- 6	4				30
LEVEL 15					6	4				10
LEVEL 14					6	4				10
LEVEL 13					6	4				10
LEVEL 12					6	4				10
LEVEL 11					6	4				10
LEVEL 10					fi.	4				10.
LEVEL 9					- 6	4				10
LEVEL 8	1				6	4				10
LEVEL 7					6.	-4				10
CEVELS					- 6	4				10
LEVEL 5				4	2	4				10
LEVEL 4.				4	2	4				10
LEVEL 3				4	2	4				10
LEVEL 2 TOWER				4	2	2				9
LEVEL 1 (TOWNHOUSE L1-L2-L3)							2		- 1	7
					-					_
TOTAL	0	D.	9	16	74	68	2.	2	9	175

TOTAL SITE AREA:	2,887.70 sq Meser	PERMITTED:	FAR 4.50	12,994.65 sq Meter	139,873.25 sqt
TOTAL RESIDENTIAL FAR PROPOSED:			FAR E SO	17.991.50 to Mercy	1.89.672.73 sqf

TYPE OF USE	# OF UNITS	MIN. RATIO	MAX. RATIO	MIN. REQD.	MAX. REQU
RESIDENTIAL	7	1.1	1.3	193	228
	175				
VISITORS		0.1	0.1	18	18

LEVEL	REG. CAR	SMALL CAR	HC	VISITORS	TOTAL
LEVEL P1 (VISITORS)*	2		1	19	21
LEVEL P2	45	- 3	- 4		- 52
LEVEL PS	49	1			52
CEVEL PA	50	3			- 53
LEVEL P5	52	- 3			. 55
TOTAL	198	12	5	19	233

PHATT		

FLOOR	# OF CLASS "A" BIKE STORAGE				TOTAL
FLOUR	LOCKER (SM)	COCKER (MED)	LOCKER (LG)	LOCKER (XLG)	TOTAL
LEVELPE	196	8	7	,	211
LEVEL P2					0
LEVEL P3					0
LEVEL P4					0
LEVEL PS			1	1	0
TOTAL	196	- 8	7	0	211
CLASS "A" BIKES PROVIDED					211
CLASS "A" BIKES REQUIRED	1.2 PER UNIT 2			210	

Contract of the contract of th	
# OF CLASS "B" BIKES REQUIRED	- 5
# OF CLASS "B" BIKES PROVIDED	6

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conditions above on the disease.

Drawing Issue Date

	Revision Schedule						
4	Rev#	Date	Description				
ч	1	JUN 02-2021	ISSUED FOR DP				
ij			RE-ISSUED FOR DP				
d	3	SEPTEMBER-2023	RE-ISSUED FOR DP				
Н	4	OCTOBER-2023	RE-ISSUED FOR DP				



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vancouver ac vaz zio canada

set

solterra

rolliorchibacis.com

SUITE ONE

1600 HOWE ST

Development Corp.

Project 15200 GUILDFORD DRIVE

Drawing Title
PROJECT STATISTICS

П	Date:	Project No.
	NOVEMBER - 2023	19-63
	Scale	Drawing No.
	Drawn Bv:	A0-04
		70-04
	HR	
	File name:	I



1- ISOMETRIC VIEW FROM NORTH WEST

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conditions above on the diamensions.

Drawing Issue Date

Rev#	Date	Description
1	JUN 02-2021	ISSUED FOR DP
2	DECEMBER-2022	RE-ISSUED FOR DP
3	SEPTEMBER-2023	RE-ISSUED FOR DP
4	OCTOBER-2023	DE-ISSUED FOR DR

RAFIIA

O SUITE ONE
Z 1600 HOWE ST
VANCOUVER BC
VSZ 219 CANADA

Development Corp

15200 GUILDFORD DRIVE

Drawing Title
ISOMETRIC VIEWS

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informed of any variations from the dimensions and
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	rision		

Rev#	Date	Description
1	DECEMBER-2022	RE-ISSUED FOR DP
2	SEPTEMBER-2023	RE-ISSUED FOR DP
3	OCTOBER-2023	RE-ISSUED FOR DP





15200 GUILDFORD DRIVE

NORTH EAST VIEW & NORTH TOWNHOUSES

Date:	Project No.
NOVEMBER - 2023	19-63
Scale	Drawing No.
1:1000	
Drawn By:	A0-21
HR	
File name:	
	Rev:



2- MAIN ENTRANCE FROM GUILDFORD DRIVE

152 STREET


4 - KEY PLAN




3- NOTH TOWNHOUSES ELEVATION



3. CLEAR LOW-E GLASS IN PREFINISHED ALUMINUM FRAME (CHARCOAL GREY)

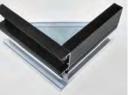

PREFINISHED ALUMINUM WINDOW FRAME (FOR # 3 & 4) (CHARCOAL GREY)

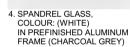





1. COATED ARCHITECTURAL CONCRETE COLOUR: B. MOORE - PM-4 (BRILLIANT WHITE)



2. WINDOW WALL SYSTEM WITH INSULATED ALUMINUM PANELS COLOUR: B. MOORE - PM-4 (BRILLIANT WHITE)



ALUMINUM RAILING (CHARCOAL GREY)



6. PREFINISHED ALUMINUM (CHARCOAL GREY) FOR GUARD RAILS & PRIVACY SCREEN FRAMES



7. FIBERGLASS DOOR AT TOWNHOUSE ENTRY WOOD GRAIN TEXTURE



9. PREFINISHED METAL DOORS AND MISC. METAL COLOUR: (CHARCOAL GREY)



B. MOORE - PM-4 (BRILLIANT WHITE) WITH LAMINATED SAFETY GLASS WITH FROSTING EFFECT

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shall verily and be responsible for all dimensions
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conditions shown on the drawing.

Drawing Issue Date

Revision Schedule					
v#	Date	Description			
	DECEMBER-2022	RE-ISSUED FOR DP			
	SEPTEMBER-2023	RE-ISSUED FOR DP			
	OCTOBER-2023	RE-ISSUED FOR DP			




Development Corp.

15200 GUILDFORD DRIVE

Drawing Title MATERIAL BOARD

ste:	i roject ivo.
OVEMBER - 2023	19-63
ale	Drawing No.
	4004
awn By:	A0-24
R	
e name:	



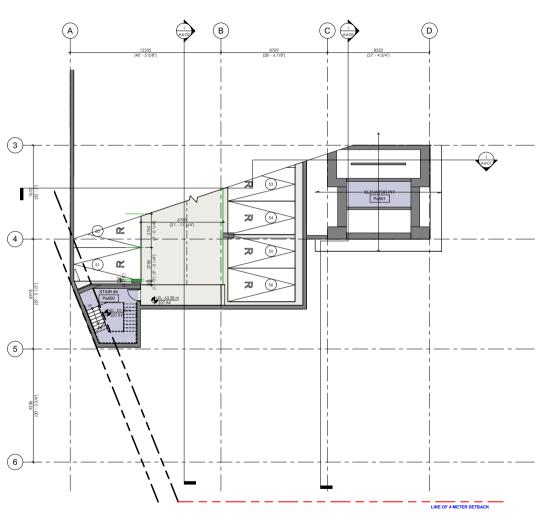

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informed of any variations from the dimensions and
conditions above on the diamensions.

Drawing Issue Date

Rev#	Date	Description
1	JUN 02-2021	ISSUED FOR DP
2	DECEMBER-2022	RE-ISSUED FOR DP
3	SEPTEMBER-2023	RE-ISSUED FOR DP
4	OCTOBER-2023	RE-ISSUED FOR DP





Development Corp


15200 GUILDFORD DRIVE


Drawing Title LEVEL P5 FLOOR PLAN CONT'D.

Date:	Project No.
NOVEMBER - 2023	19-63
Scale	Drawing No.
1:100	
Drawn By:	[↑] A2-01
HR	
File name:	
	Rev:

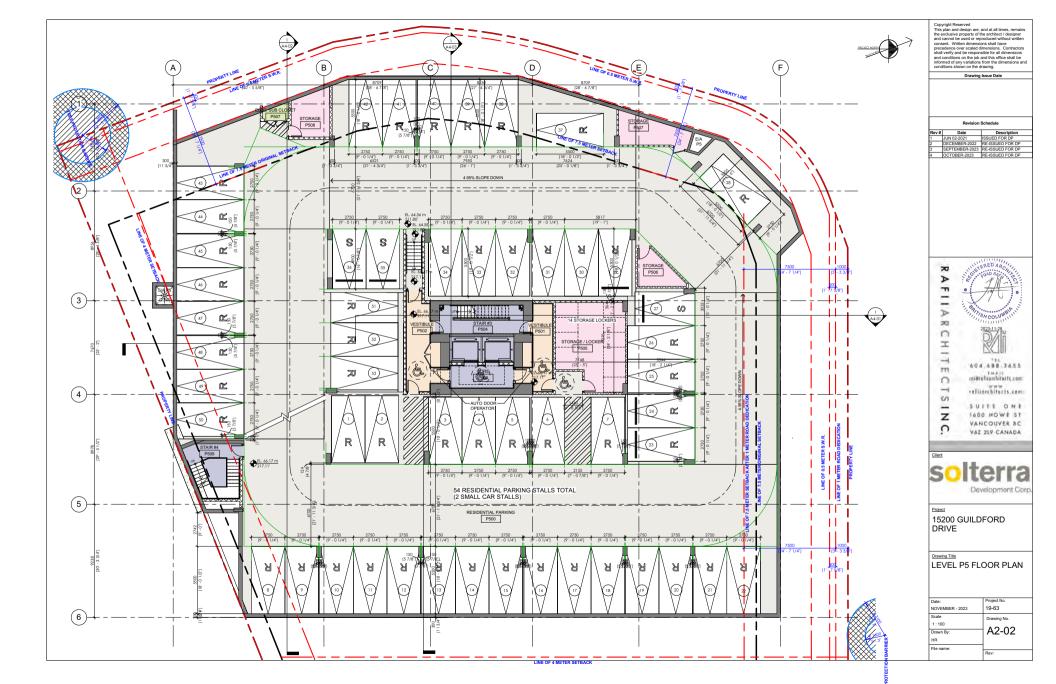

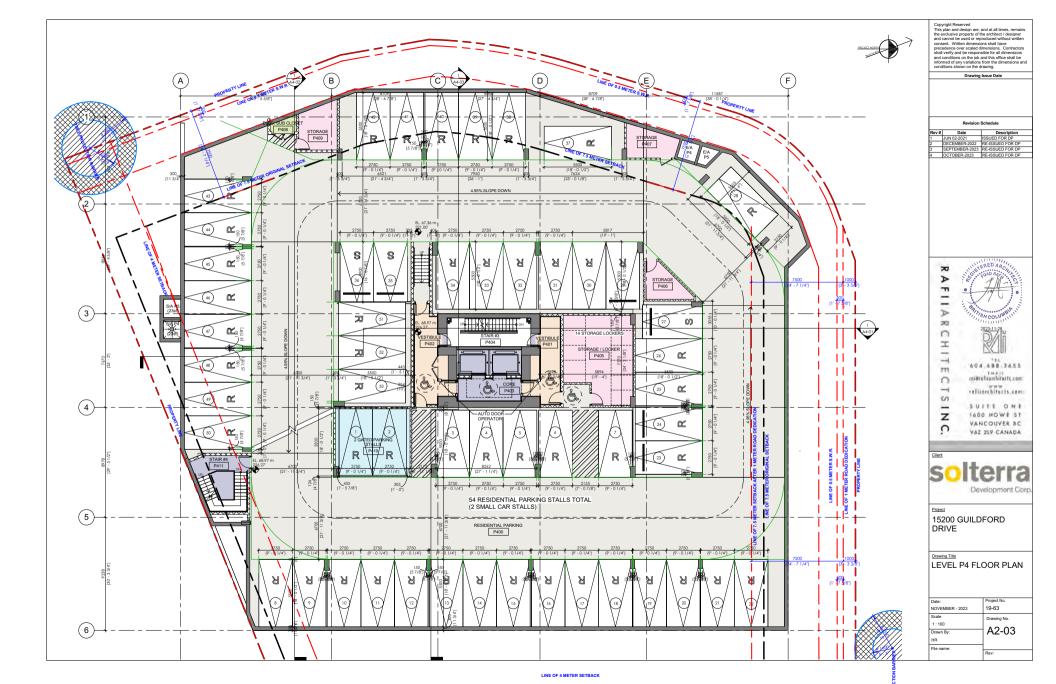


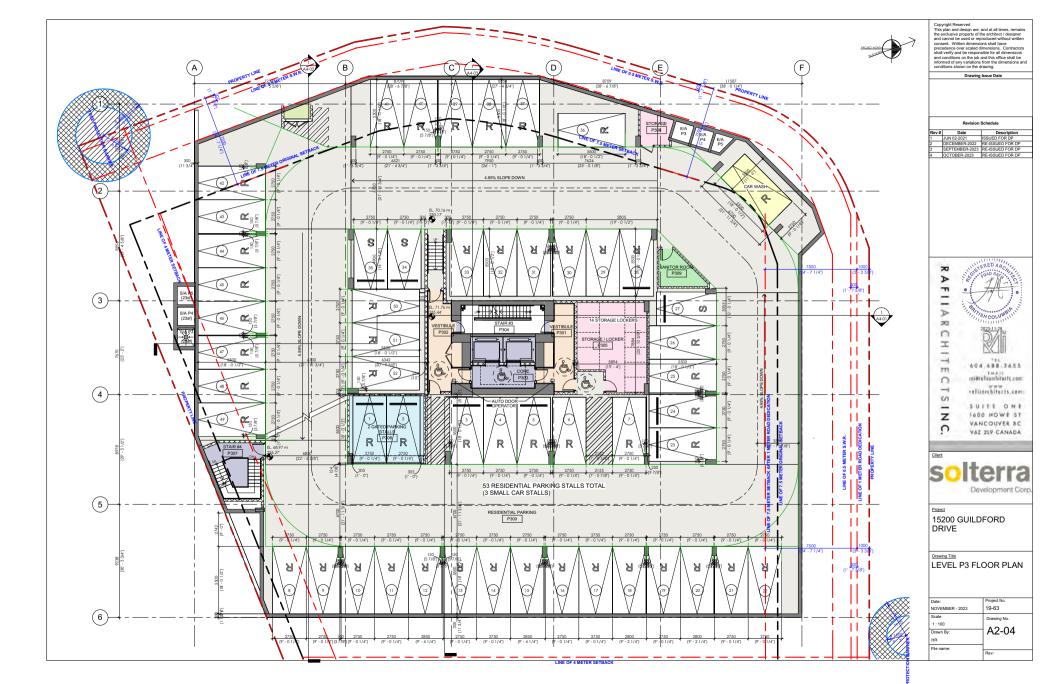


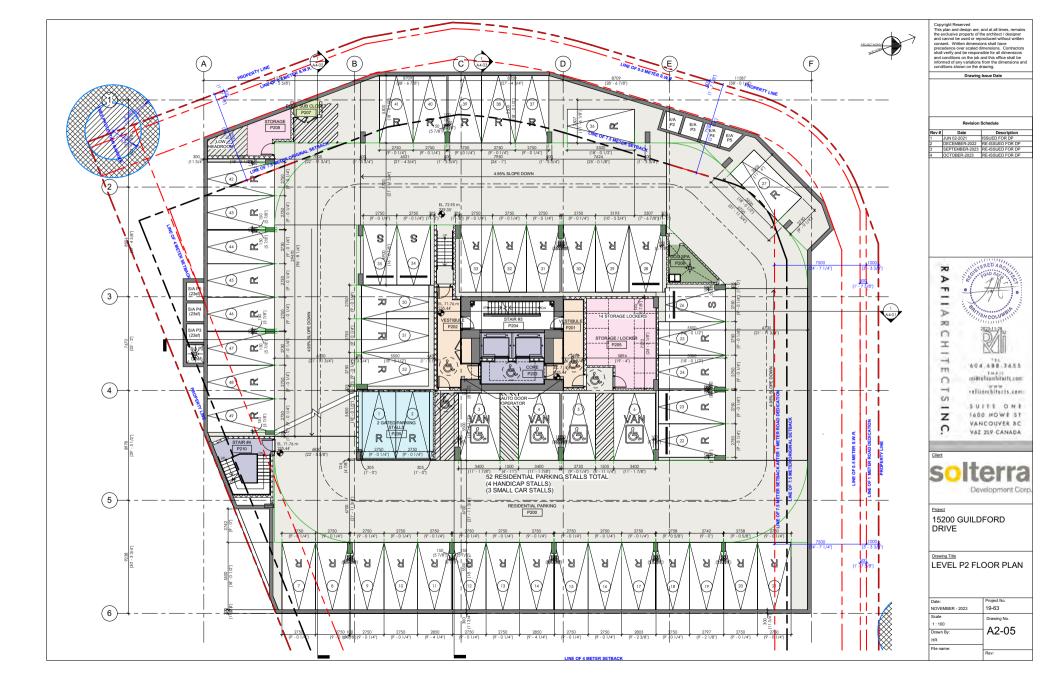






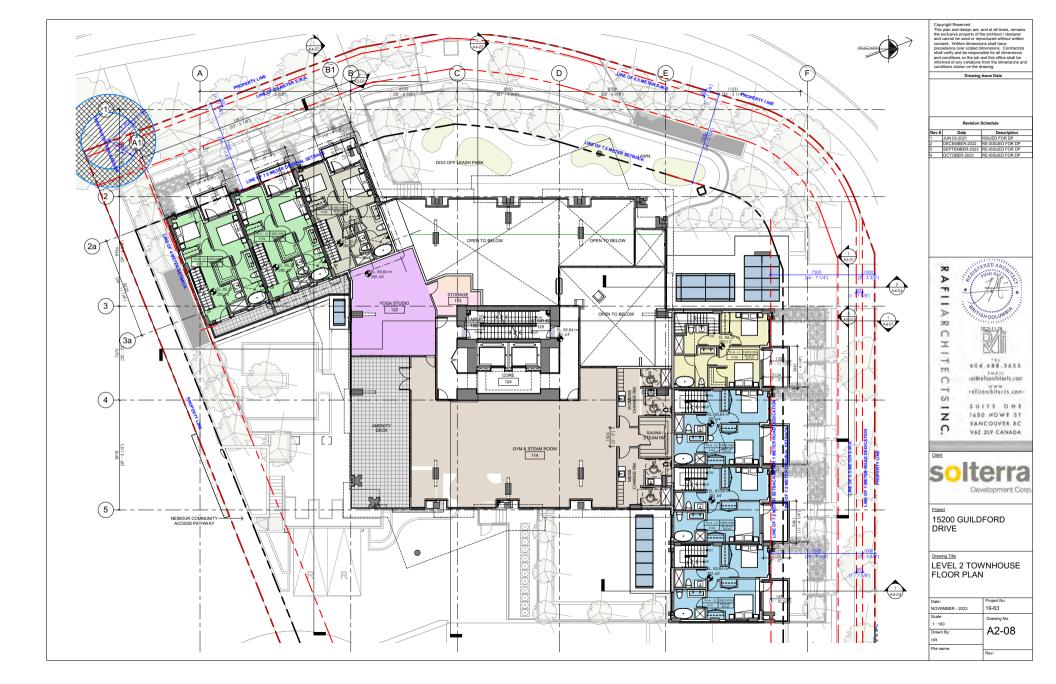

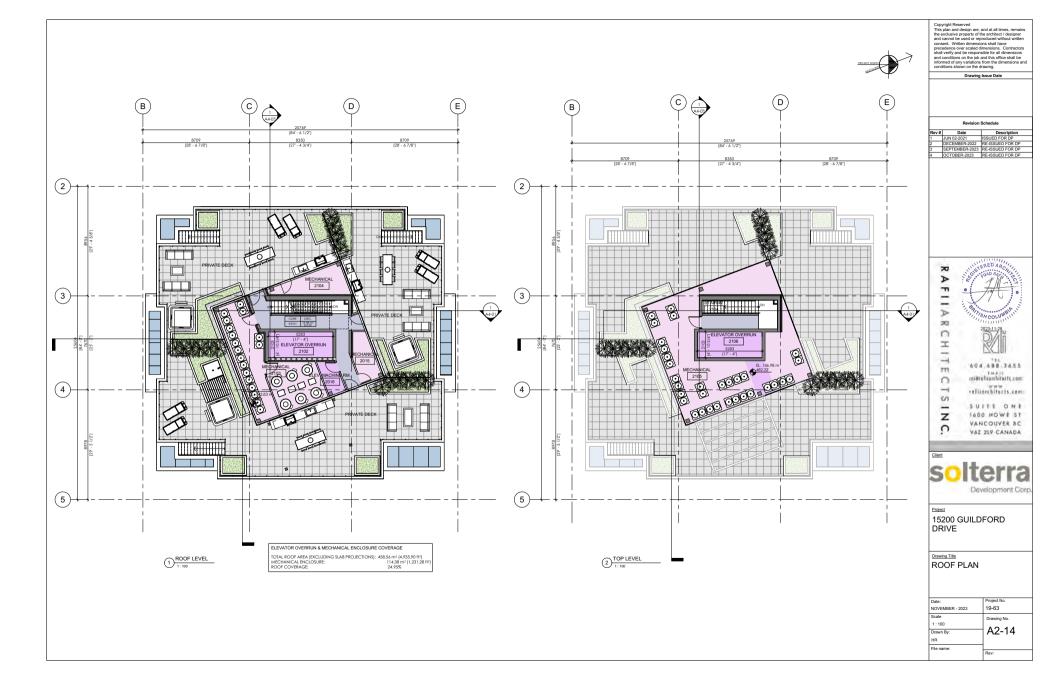

MATERIAL LEGEND				
1	COATED ARCHITECTURAL CONCRETE COLOUR: B. MOORE - PM-4 (BRILLIANT WHITE)	6	PREFINISHED ALUMINUM (CHARCOAL GREY)	
2	WINDOW WALL SYSTEM WITH INSULATED ALUMINUM PANELS COLOUR: B. MOORE - PM-4 (BRILLIANT WHITE)	7	FIBERGLASS DOOR AT TOWNHOUSE ENTRY WOOD GRAIN TEXTURE	
3	CLEAR LOW-E GLASS IN PREFINISHED ALUMINUM FRAME (CHARCOAL GREY)	8	PRIVACY SCREEN - LAMINATED SAFETY GLASS WITH FROSTING EFFECT	
4	SPANDREL GLASS, IN PREFINISHED ALUMINUM FRAME (CHARCOAL GREY)	9	PREFINISHED METAL DOORS AND MISCELLANEOUS METAL COLOUR: (CHARCOAL GREY)	
5	CLEAR GLASS IN PREFINISHED ALUMINUM RAILING (CHARCOAL GREY)	10	METAL CANOPY, COLOUR: B. MOORE - PM-4 (BRILLIANT WHITE) - WITH LAMINATED SAFETY GLASS	

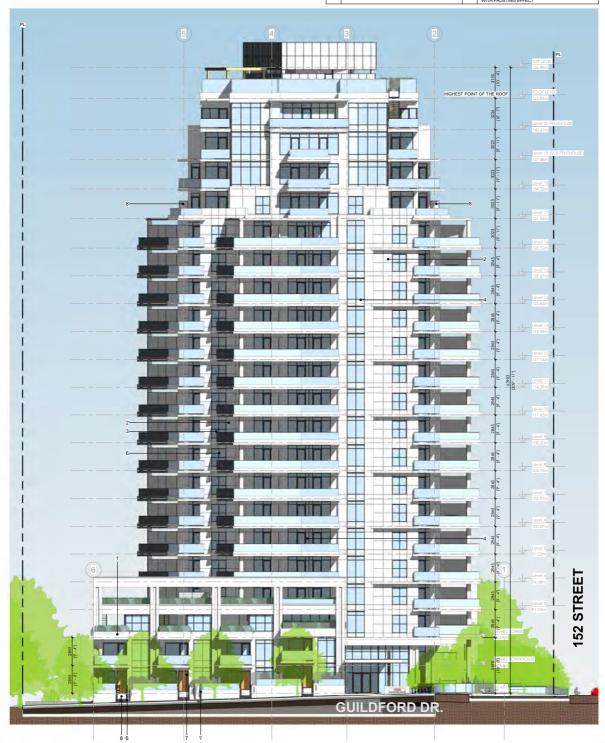


Rev:	
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A-0-	Drawn By:
3	1:125
Drawing No.	Scale
19-63	NOVEMBER - 2023
Project No.	Date:
'ATION	NORTH ELEVATION
	Drawing Tale

15200 GUILDFORD DRIVE Iterra


SUITE ONE
1600 HOWE ST
VANCOUVER BC
V62 219 CANADA



Drawing Issue Date

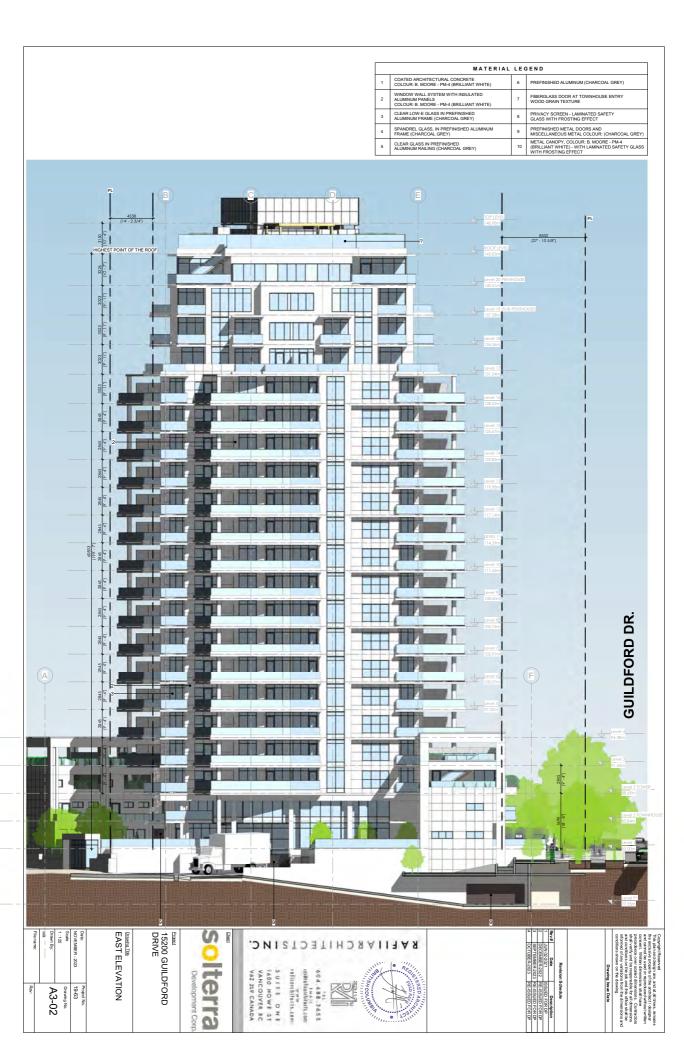

	MATERIAL LEGEND				
1	COATED ARCHITECTURAL CONCRETE COLOUR: B. MOORE - PM-4 (BRILLIANT WHITE)	6	PREFINISHED ALUMINUM (CHARCOAL GREY)		
2	WINDOW WALL SYSTEM WITH INSULATED ALUMINUM PANELS COLOUR: B. MOORE - PM-4 (BRILLIANT WHITE)	7	FIBERGLASS DOOR AT TOWNHOUSE ENTRY WOOD GRAIN TEXTURE		
3	CLEAR LOW-E GLASS IN PREFINISHED ALUMINUM FRAME (CHARCOAL GREY)	8	PRIVACY SCREEN - LAMINATED SAFETY GLASS WITH FROSTING EFFECT		
4	SPANDREL GLASS, IN PREFINISHED ALUMINUM FRAME (CHARCOAL GREY)	9	PREFINISHED METAL DOORS AND MISCELLANEOUS METAL COLOUR: (CHARCOAL GREY)		
5	CLEAR GLASS IN PREFINISHED ALUMINUM RAILING (CHARCOAL GREY)	10	METAL CANOPY, COLOUR: B. MOORE - PM-4 (BRILLIANT WHITE) - WITH LAMINATED SAFETY GLASS		

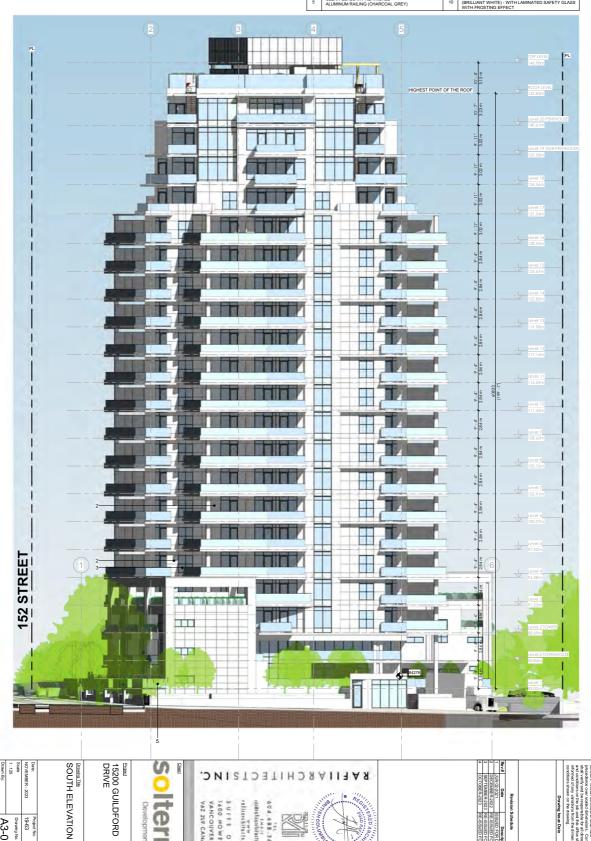

Date: NOVEMBER - 2023 Project No. 19-63 Drawing No. A3-03

15200 GUILDFORD DRIVE Development Corp

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oca ou B. 3655 SUITE ONE 1600 HOWE ST VANCOUVER BC V62 219 CANADA



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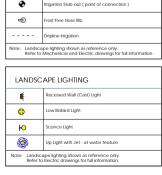
Drawing Issue Date




DRAWING LIST L - 1.0 Landscape Legend + Schedule L - 1.1 Landscape Site Plan L - 1.2 Landscape Planting Plan 3/32" = 1'-0" L - 1.3 Landscape Lighting Plan 3/32" = 1'-0" L - 1.4 Landscape FencingPlan 2/22" - 1' 0" 3/32" - 1'-0" L - 1.5 Landscape Level 2 L-16 Landscape Level 3 3/32" = 1'-0" L - 1.7 Landscape Roof Plan 1/8" = 1'-0" L - 2.1 Landscape Section As Indicated L - 2.2 Landscape Section As Indicated L - 2.3 Landscape Section As indicated L - 3.1 Landscape Details As Indicated 1 - 3.2 Landscape Details As Indicated L - 3.3 Landscape Details As Indicated L - 3.4 Landscpae Details As Indicated L - 3.5 Landscape Details As indicated L - 3.6 Landscape Details As indicated


GRADING + DRAINAGE			
+ TS 83.00m	top of stair		
+ BS 81.00m	bottom of stair		
+ TW 83.00m	top of wall		
+ BW 81.00m	bottom of wall		
+ 83.00m	spot elevation		
+ FG 81.50m	finished grade		
+ BG 81.35m	building grade		
+ HP 83.35m	high point		
+ LP 81.35m	low point		
+EX 8.75	existing elevation (as per survey)		
2%	direction/percent slope		
	break in slope		
DN 4R	direction/number of risers down		
TD 82.00m +	Trench Drain		
AD 82.00m +■	Area Drain		
I			


LANDSCAPE IRRIGATION



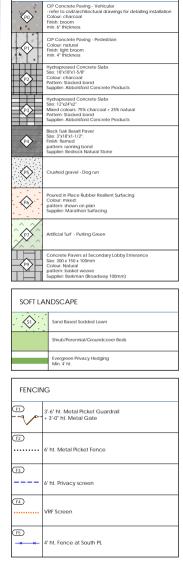

HARD SURFACING

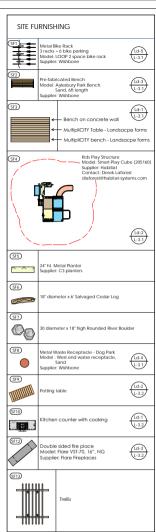

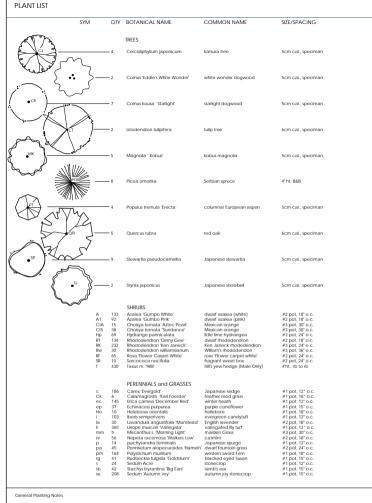

- All work shall meet or exceed the requirements as outlined in the Current Edition of the Canadian Landscape Standard. Plant sizes and related container classes are specified according to the Canadian Landscape Standard Current Edition.
- For container classes #3 and smaler, plant sizes shall be as shown in the plant lat and the Standard: for all other plants, both plant itse and container class shall be as shown in the plant list and the Standard. For all other plants, both plant itse and container, these shall be as defined in the CNLA Standard. All On-site Soft Landscape, Areas to be imigated to IMAE Standards with a high efficiency trigation system.
- Design of irrigation system to be submitted to consultant and reviewed prior to installation. The irrigation system design and installation shall be in accordance with the irrigation industry of BC Standards and Guidelines All trees to be staked in accordance with CNLA Standards.
- Any plant substitutions around Kids Play Area are to be non-toxic.

07	NOV 28, 2023	ADP Responce
06	NOV 23, 2023	ADP Revisions Review
05	OCT 26, 2023	Submission ADP
04	OCT 04, 2023	Issued for DP Re-Submission
03	SEPT 05, 2023	Issued for DP Re-Submission
02	DEC 01, 2022	Issued for DP
01	MAY 17, 2021	Issued for DP
no.:	date:	Item:
Revisions:		



ON BEHALF OF STEPHEN VINCENT - ON VACATION AT THE TIME OF SUBMISSIO

Project-

15200 GUILDFORD DRIVE. SURREY, BC

File #: 7921-0153-00

Drawn by: IC Checked by: SV Date NOV 28 2023 Scale-

Drawing Title:

Landscape Legend+ Schedule


Project No. 20047

heet No.

L - 1.0





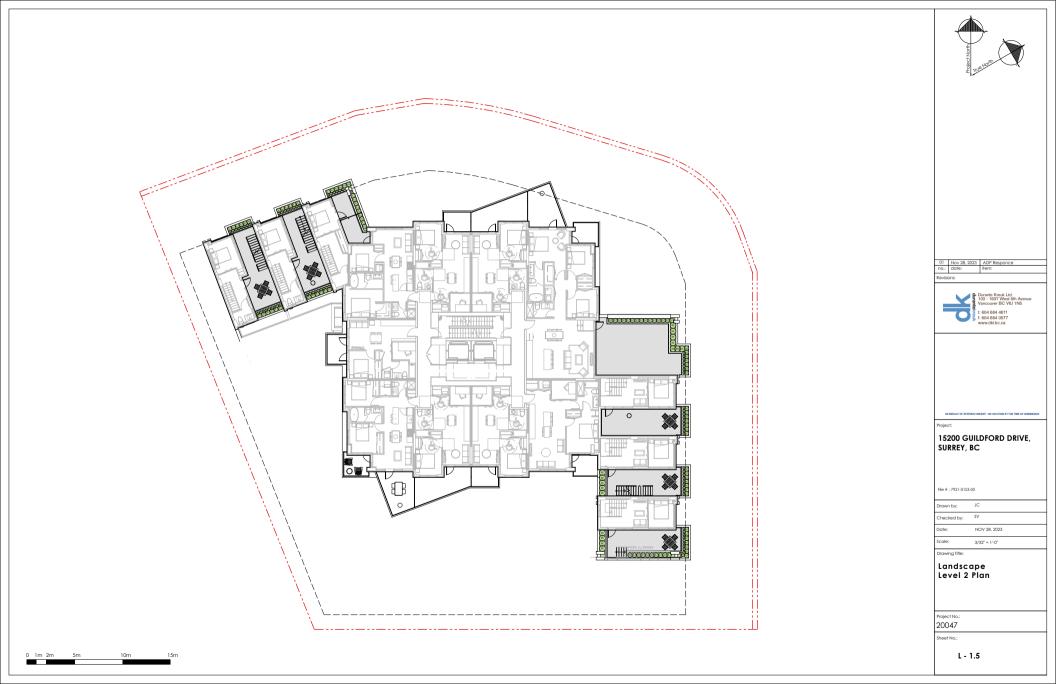





01		ADP Responce
no.:	date:	item:

t: 604 684 4611 f: 604 684 0577 www.dkl.bc.ca

15200 GUILDFORD DRIVE, SURREY, BC


File #: 7921-0153-00

Drawn by:	JC
Checked by:	SV
Date:	NOV 28, 2023

3/32" = 1'-0"

Landscape Level 3 Plan

L - 1.6

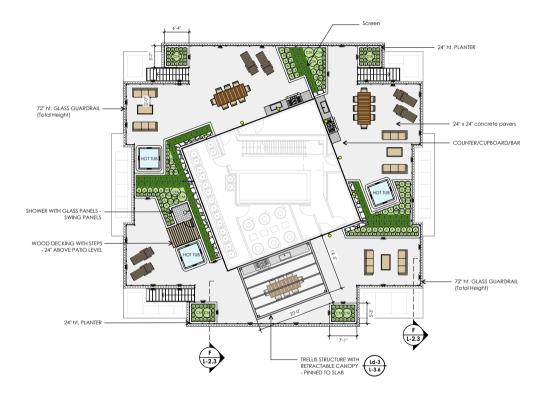



5	NOV 28, 2023	ADP Responce
4	OCT 26, 2023	Submission to ADP
3	OCT 04, 2023	Issued For DP Re-Submission
2	SEPT 05, 2023	Issued For DP Re-Submission
1	Dec 01, 2022	Issued For DP
no.:	date:	item:

Pavisions



DIALF OF STEPHEN VINCENT - ON VACATION AT THE TIME OF SUI

Project:

15200 GUILDFORD DRIVE, SURREY, BC

File #: 7921-0153-00

Drawn by:	JC .
Checked by:	SV
Date:	NOV 28, 2023
Scale:	1/8" = 1'-0"

Drawing Title:

Landscape Roof Plan

Project No.: 20047

Sheet No.

L - 1.7

RECOGNITION FOR MULTIPLICITY

2016 Green Good Design Award

2015 International Design Excellence Award (IDEA)

2015 Red Dot Award

2015 Green Good Design Award

2015 Next Generation Luminaires Award

2014 International Design Award

2014 BOY Award

2014 Good Design Award

2014 Spark Award

dxwxh





13" × 15" × 47"















L-1.1

SCALE NTS

MuligiCDY" is available fully assembled by to make with the attitude of a make beautiful and an in-Not every able and assembly frontly by insured insurmarkets Contact Lawlengos Forms Tor density

MultipliCITY" is designed by Yves Behar and fusiproject. Location Photography (ICSD, La Jolla, California Country of new restrict to charge without colors Landscape Forms supports the Landscape Architecture Foundation at the Second Century level @2017 Landscape Foreis, by: Printed in U.S.A.

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Uniquely designed for ages 2-5, with a particular emphasis on younger children ages 2-3. The tube has a unique look, bringing a sculptural, modernistic feel to the play space. The structure incorporates 5 GripX-textured decks, table tors, and seats, built-in shade and cut-outs in punels to eate shadow play on decks and provide clear sight lines for supervision. The compact footprin fits into small spaces while packing in 14 activities to keep kids busy and entertained in a safe and developmentally-appropriate way, including:

Table Panel (underneath deck)
 Table Panel (underneath deck)
 Activity Table with Bench
 Mirror Panel
 Crawl-through Panel

· Magnet Stack

Austiable for Direct Bury or 2" Surface Mount - \$20,878 (plus \$4,824 for installation)

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wife furnishings

Super Durable Powder Coated Aluminum Pipe Standard Coloans: Brown State, Wittel Bildge B. Nimelic Lichen, Emeinic Hart, Strey Cold, Skritanni Shker, Prickant Sand, Grissey Bed, Black Testanni, Earlin Cole, Nobbe Reveau, Belgiere Robet. Flamia Red Pastal Change, Lignal Waler. Taiffic yolinia. (Sin amb-

PRODUCT SPECIFICATIONS

Schoolie 40 Aluminum Pipe

rose Wage, Window White, Vellage, Greener

CUSTOMIZED SOLUTIONS

In-ground Mounting

PRODUCT DIMENSIONS

widest point.

100% RECYCLABLE

(Setup Charges May Apply)

Calvanavid Short dinagri option

INST-1 Stamless steel mounting lift for contrete

Wall Thickness | 2 inches /51 mm

Diameter at 40 inches / 1016 mm

Weight 9.5 lbs / 4.3 kg

Height 44 inches / 112 mm

Ld-2

Smart Play Cube - Habitat Systems

LOOP 2 SPACE BIKE RACK

MultipliCITY Table and Bench - Landscpae Forms ld-1



DESIGNER NOTES





CUSTOMIZED SOLUTIONS

Setup Charges May Apply! Octoral Centre Arm Stainless Steel Bolt-Down Kit

PRODUCT DIMENSIONS

RECYCLED CONTENT

for a tender they were awarded. The tender, however, had specfications that did not match any of the benches we had or at the required price point. We took on the challenge and carrie up with this design. The Aylesbury bench borrows design cues and compo nents from a couplir of our other brenches allowing us to maintain a comfortable, stable seating surface while at the same time capitallong on reduced fabrication time and material cost. The bench's name comes from an English fown where the distributor's family lived before immigrating to Canada.

One of our distributors asked us to design a bench specifically

AVAILABLE RECYCLED PLASTIC LUMBER COLDURS

100% Canadian Made

100% RECYCLABLE



Height 31 inches / 787mm

Depth 23 inches / 584mm

Length 72 inches / 1829mm

Seat Height 17.5 inches / 445mm Seat Depth 17 inches / 432mm

Weight 126 lbs / 57 kg

75% RECYCLED CONTENT BY WEIGHT



Wishbone Site Furnishings | #210-27090 Gloucester Way | Langley, BC CANADA V4W 5Y5 1.866.626.0476 salesawishbonehd.com

Aylesbury Park Bench - Wishbone Site Furnishings SCALE NTS



West End Waste Receptacle - Wishbone Site Furnishings

DESIGNER NOTES it looks great over years of service. 10th Canadian Wade

Providing accommodation for up to 2 takes, the Loop Bike Rack is a simple yet familiar design. Extremely durable and functional, this hike rack looks most alamoute classic or contemporary lands one. architecture. What makes our Loop Bille Rack design unique are the ministrials we use in its construction. Praditional steel bike racks tend. RECYCLED CONTENT to be fellery and not very corrosion resistant over time with-old galvanization. Our new thick walled aluminum pipe design provides similar strength qualities to steel ensuring safe storage of the bikes while the light weight conssion resistant aluminum ensure





Wishbone Site Furnishings | #210-27090 Glosscenter Way | Langley, BC CANADA V4W 3Y5

Loop 2 Space Bike Rack - Wishbone Site Furnishings

1.866.626.0476 sales@wishbonehd.com

L-1.1

SCALE NTS

04	OCT 26, 2023	Submission to ADP
03	OCT 04, 2023	Issued for DP Re-Submission
02	SEPT 05, 2023	Issued for DP Re-Submission
01	DEC 01, 2022	Issued for DP
no.:	date:	item:
Revisi	ons:	

05 NOV 28 2023 ADP Response



ON BEHALF OF STEPHEN VINCENT - ON VACATION AT THE TIME OF SUBMISSIO

roject

15200 GUILDFORD DRIVE. SURREY, BC

File #: 7921-0153-00

Drawn by: IC. SV Checked by:


Date: NOV 28 2023 Scale: AS INDICATED

Drawina Title: Landscape

Details

Project No. 20047

heet No.

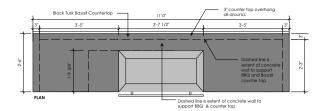


NOTE:

1. Contractor to co-ordinatecuntertop cutout with bbg supplier (Supplier to provide deimensioned bbg cut out template).

NOTE:

1. Contractor to review the BILEX730RBI Assembly Procedure prior to forming and pouring BBQ opening and base, to ensure that the installed base will meet all BBQ specifications requirements. Gas BBQ shall be as specified or pre-approved equivalent.
 Locate valve box with regulator within planting bed.

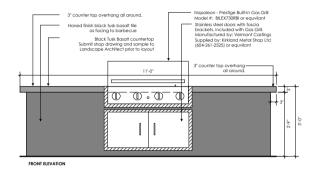



- 3" thick counterton 2'-6" Built-In Gas Grill Model #: BILEX730RB tw 273.81 Stainless steel doors under arill SECTION 'A'

- Adjacent planter

Outdoor kitchen with gas BBQ -Amenity Deck

Scale: 3/4" = 1'-0"

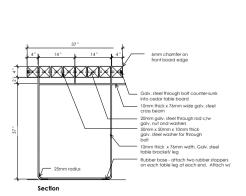

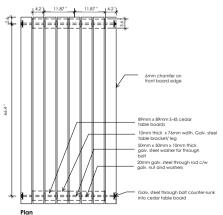

Cedar Potting Table -Amenity Deck

Scale: 1" = 1'-0"





FLARE VENT-FREE SEE THROUGH 70" WITH 16" GLASS OUTDOOR FIREFLACE SKU: VEST70

SUBJECT	DETA	ns .
GAS TYPE OPTIONS	Natural Gas (NG) or L	iquid Propane (LP)
FIREBOX CONSTRUCTION	Combination of 3.16 &	3.04 Stainless Steel
SAFETY STANDARD	ANSI 221 97/CSA 2 41 for	Outdoor Gas Eveplaces
GAS VALVE SYSTEM	Honeywell Electronic is	gnition Valve System
ELECTRICAL REQUIREMENTS	110 viols, 15 amps, GF) Protected. (C	Dedicated Breaker Recommended)
FIREPLACE OPENING HEIGHTS	16° Regular Opening	24" High Opening
LIGHTING SYSTEM	Multi-Colored RGIII	LED Light System
BURNER(S)	Stainless Stee	Burner (s)
WEIGHT	IN CRATE (LBS)	UNCRATED (LBS)
WEIGHT	220	160
INTERIOR MEDIA OPTIONS	Clockranics	Siles Media

Vent Free Product Specifications

All Vent Free Flare Fireplaces are for outdoor operation only and can be run with Natural Gas (NG) or Liquid Propane (LP), using the Honeywell commercial gas valve. The gas type must be specified so the proper equipment can be provided for safe operation. All Vent Free Flare Fireplaces must be installed maintaining required clearance to combustibles and be installed according to Flare Fireplaces requirements as presented in the Impalation Atanual, while complying with all existing local codes. If no codes exist, then the current CSA installation standards must be followed.

MODELS	GAS	PRESSURE	MANIFOLD PRESSURE	вти	ORIFIC	CE SIZE	BURN	ER SIZE
VE-ST-70	(NG)	7-8" WC	54	75,000	1000	1000	30.7*	30.7
VF-5T/70	(LP)	10-13" WC	30.4	73,000	420	420	30.74	30.7*

PARTS INCLUDED WITH FIREPLACE PURCHASE

- 5" Wind Guard Tempered Glass Panel
- 1 Clausic Media Selection
- Fower Adapter
- · RGB LED Lighting System
- Storm Doors

OPTIONAL ADD-ON ACCESSORIES AND FEATURES

- Reflective Back and Side Panel(s)
- · Natural Gas or Liquid Propane Conversion Kit
- Extra Classic or Premium Media Options

*Inclue shutoff timer/controler

Double-sided fire place

23 ADP Responce 02 SEPT 05, 2023 Issued for DP Re-Submission 01 DEC 01, 2022 Issued for DP



15200 GUILDFORD DRIVE. SURREY, BC

File #: 7921-0153-00


roject


Drawn by: JC Checked by: SV NOV 28 2023 Date: Scale: AS INDICATED

Drawing Title: Landscape Details

Project No.: 20047

iheet No.:

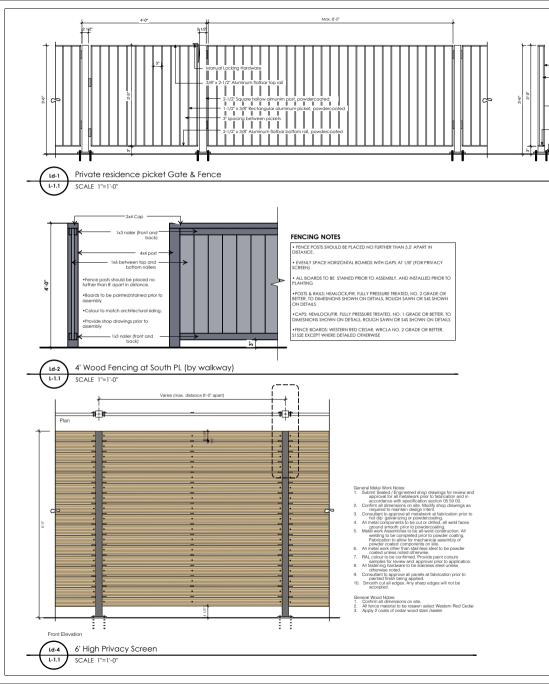

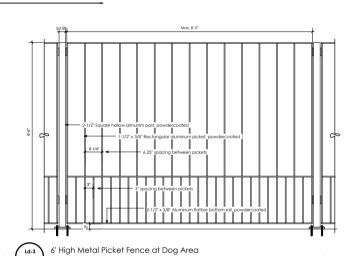

Typical Metalwork Notes:

Typical Metalwork Notes:

1. Submit Sealed / Engineered shop drawings for review and approval for all metalwork prior fabrication and in accordance with specification section 05 50 00.

2. Confirm all dimensions on site. Modify as

Consultant to approve all metalwork at fabrication prior to paint application.

Metal Handrails to be powdercoat RAL color to be selected to match building accent. Assembly to be all-weld construction.

Ensure all weld faces are ground smooth.

5. Steel metal work other than stainless steel to be powder coated as noted.

= 2-1/2" Square hollow almunim post

3/8" x 2-1/2" Aluminum flatbar top rail

2-1/2" x 3/8" Aluminum flatbar bottom rail.

1-1/2" x 3/8" Rectangular aluminum picket.

powdercoated

- Max. 3' gap

6" x 6" x 3/8" Base plate

L-1.1/1.4



Reference image for VRF Screen - Size to be determined

01 [DEC 01, 2022	Issued for DP Re-Submission Issued for DP		
		Issued for DP		
00: 1				
	date:	item:		
Revisions:				
Kevisions:				

05 NOV 28, 2023 ADP Responce 04 OCT 26, 2023 Submission to AD

Durante Kreuk Ltd.
102 - 1637 West 5th Avenu
Vancouver BC V6J 1N5

6 t: 604 684 4611

6 t: 604 684 0577
www.dkl.bc.ca

HALF OF STEPHEN VINCENT - ON VACATION AT THE TIME OF SUBMISSI

rolect:

15200 GUILDFORD DRIVE, SURREY, BC

File #: 7921-0153-00

 Drawn by:
 JC

 Checked by:
 SV

 Date:
 NOV 28, 2023


Scale: AS INDICATED


Drawing Title:

Landscape Details

Project No.: 20047

Sheet No.:

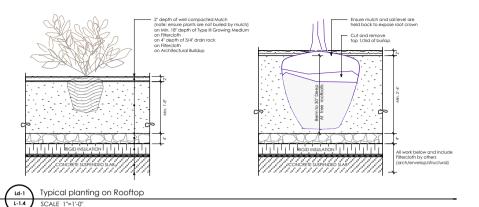

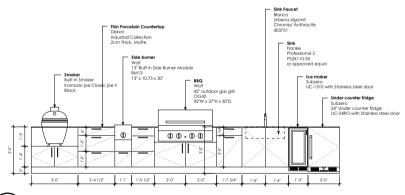

Ld-3 Outdoor kitchen on Rooftop

L-1.4 SCALE 1/2"=1'-0"


- Note:

 On Cut all Pavers as required to maintain pattern/layout as shown on Layout Plans.

 All povers to be cut with Concrete Stone Sow, no gallotine cuts will be allowed.


 Min. pover cut to be no less than 1/36 of aligning size.

 Mangble Layout to be reviewed and approved by Landscape Architect prior to finalizing installation. Provide 2 "Dours onlate to schedule site review"

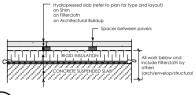

Hydrapressed slabs on Rooftop L-1.4

SCALE 1"=1'-0"

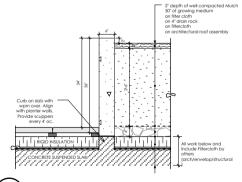

Ld-4 Concrete planter on Rooftop

SCALE 1"=1'-0"

L-1.4

Revisions:



ON BEHALF OF STEPHEN VINCENT - ON VACATION AT THE TIME OF SUBMISSION

roject

15200 GUILDFORD DRIVE. SURREY, BC

File #: 7921-0153-00

Drawn by: JC Checked by: SV NOV 28 2023 Date: Scale: AS INDICATED Drawing Title:

Landscape Details

Project No.: 20047

Sheet No.:



TO: Director, Area Planning & Development

- North Surrey Division

Planning and Development Department

FROM: Development Services Manager, Engineering Department

DATE: November 27, 2023 PROJECT FILE: 7821-0153-00

RE: Engineering Requirements

Location: 15200 Guildford Dr

DEVELOPMENT PERMIT/DEVELOPMENT VARIANCE PERMIT

The following are requirements associated with Development Permit, and are conditions of the subsequent Building Permit issuance of the proposed building.

Property and Right-of-Way Requirements

• Applicant to confirm with the Ministry of Transportation and Infrastructure regarding if any dedication or construction requirements.

Works and Services

- Construct sidewalk upgrades along Guildford Drive, if required.
- Provide downstream Storm and Sanitary system analysis, and address an capacity constraint(s) as required.
- Construct adequately-sized service connections (water, storm and sanitary), complete with inspection chambers/water meter, to the lot. Abandonment of surplus connection(s), if any, is also required.

A Servicing Agreement may be required.

Jeff Pang, P.Eng.

Jeffy lang

Development Services Manager

M51



Department: Planning and Demographics

Date: October 30, 2023
Report For: City of Surrey

Development Impact Analysis on Schools For:

Application #: 21 0153 00

The proposed development of 175 High Rise Apartment units are estimated to have the following impact on elementary and secondary schools within the school regions.

School-aged children population projection 7

F	Projected Number of Students From This Development In:				
Е	Elementary School =	4			
S	Secondary School =	2			
Т	Fotal Students =	6			

Current Enrolment and Capacities:				
Harold Bishop Elementary				
Enrolment	497			
Operating Capacity	504			
# of Portables	0			
Johnston Heights Secondary				
Enrolment	1460			
Operating Capacity	1450			
# of Portables	1			


Summary of Impact and Commentary

The following tables illustrate the historical, current and future enrolment projections including current/approved ministry operating capacity for the elementary and secondary schools serving the proposed development.

Harold Bishop Elementary is in a maturing neighbourhood. With minimal development permit applications asking for modest density increases, the 10 year enrolment projections reflect a stable and level trend. Because current and future enrolment demand can be accommodated by the school's existing capacity, no additions are being considered at this time. With the proposed large scale development proposed along 152nd, it can change the urban landscape of the area and also fue growth to counteract the previous flat line enrolment trend that sat below or at the school capacity. This catchment will be monitored over the next year to further understand the impact that the new larger residential development currently considered by the Surrey Development Services.


Johnston Heights also serves a maturing neighbourhood and it is showing the same enrolment trend as Harolld Bishop Elementary; stable and level. The school currently operates a District IB Middle and International Baccalaureate Program that has stabilized the enrolment. Because current and future enrolment demand can be accommodated by the school's existing capacity, no additions are being considered at this time. However, with the pending densification around Guildford Mall and the future Skytrain line, these projections should be considered conservative.

Harold Bishop Elementary

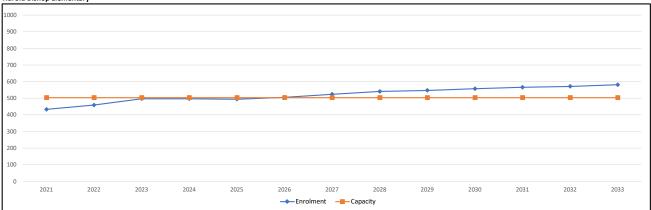

Note: If this report is provided in the months of October, November and December, the 10-year projections are out of date and they will be updated in January of next year.



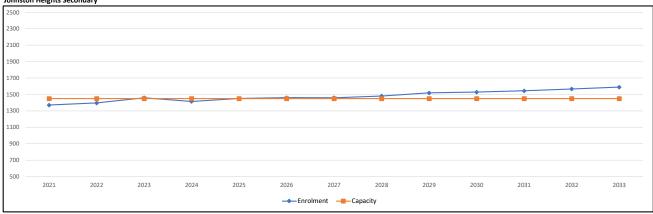

Note: If this report is provided in the months of October, November and December, the 10-year projections are out of date and they will be updated in January of next year.

Population: The projected population of children aged 0-17 impacted by the development. **Enrolment:** The number of students projected to attend the Surrey School District ONLY.

Table 3 - On-site Tree Protection and Replacement Summary

On-Site Trees	Number of Trees
Protected Trees Identified - on-site and shared trees, including trees within boulevards and	10
proposed streets and lanes, but excluding trees in proposed open space or riparian areas.	
Protected Trees to be Removed	5
Protected Trees to be Retained - excluding trees within proposed open space or riparian	5
areas.	
Total Replacement Trees Required:	12
Alder & Cottonwood Trees Requiring 1:1 Replacement Ratio = 2	
All other Trees Requiring 2 to 1 Replacement Ratio = 5	
Replacement Trees Proposed	See landscape Plan
Replacement Trees in Deficit	See landscape Plan
Protected Trees to be retained in proposed open space /riparian areas	


 Table 4 - Off-site Tree Protection and Replacement Summary

Off-Site Trees	Number of Trees
Protected Off-site Trees to be removed	0
Total Replacement Trees Required:	0
Alder & Cottonwood Trees Requiring 1:1 Replacement Ratio =	
All other Trees Requiring 2 to 1 Replacement Ratio =	
Replacement Trees Proposed	0
Replacement Trees in Deficit	0

Summary and Plan Prepared by Goode Arboriculture Consulting





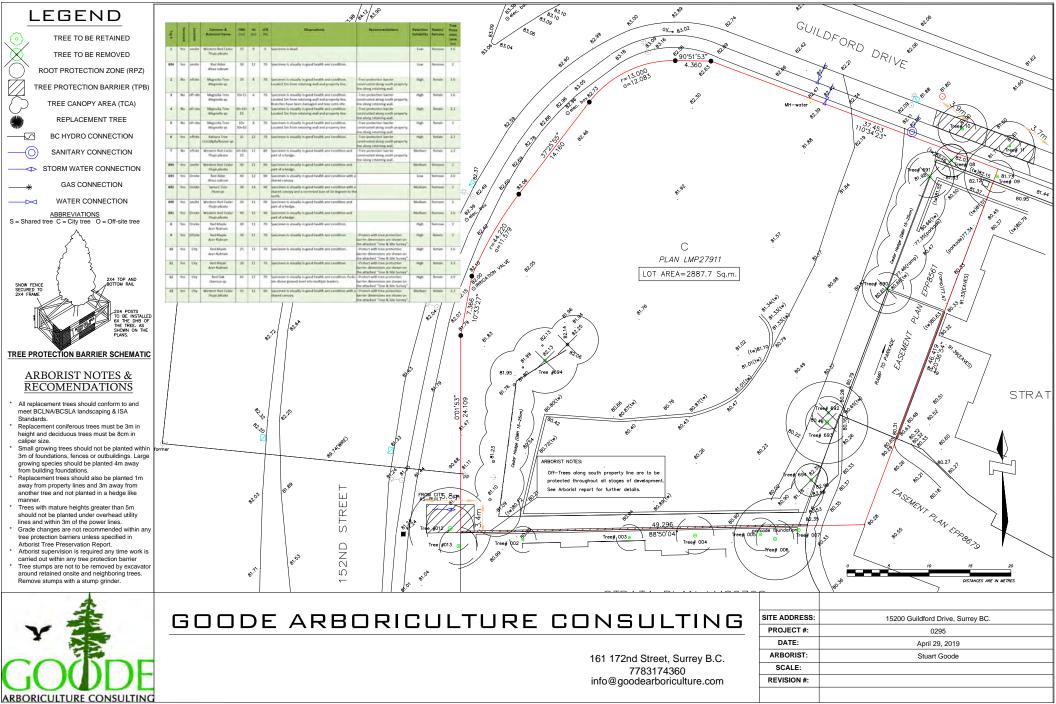

CITY OF SURREY

(the "City")

DEVELOPMENT VARIANCE PERMIT

		NO.: 7921-0153-00
Issued	l To:	
		(the "Owner")
Addre	ess of O	wner:
1.	statut	levelopment variance permit is issued subject to compliance by the Owner with all es, by-laws, orders, regulations or agreements, except as specifically varied by this opment variance permit.
2.	witho	levelopment variance permit applies to that real property including land with or ut improvements located within the City of Surrey, with the legal description and address as follows:
	Lot C	Parcel Identifier: 023-420-201 Section 21 Block 5 North Range 1 West New Westminster District Plan LMP27911
		15200 - Guildford Drive
		(the "Land")
3.	(a)	As the legal description of the Land is to change, the City Clerk is directed to insert the new legal description for the Land once title(s) has/have been issued, as follows:
		Parcel Identifier:
	(b)	If the civic address(es) change(s), the City Clerk is directed to insert the new civic address(es) for the Land, as follows:
4	Surrey	v Zoning By-law 1002. No. 12000, as amended is varied as follows:


- - (a) In Table D.1 of Part 5, Off-Street Parking and Loading/Unloading, the minimum on-site parking requirement for non-ground oriented multiple unit residential

- dwelling units is reduced to 1.1 parking space per dwelling unit for residents and 0.1 parking space per dwelling unit for visitors; and
- (b) To vary the maximum permitted lot coverage, under CD Bylaw No. 17032, from 40% to 42%.
- 5. This development variance permit applies to only that portion of the buildings and structures on the Land shown on Schedule A which is attached hereto and forms part of this development variance permit. This development variance permit does not apply to additions to, or replacement of, any of the existing buildings shown on attached Schedule A, which is attached hereto and forms part of this development variance permit.
- 6. The Land shall be developed strictly in accordance with the terms and conditions and provisions of this development variance permit.
- 7. This development variance permit shall lapse if the Owner does not substantially start any construction with respect to which this development variance permit is issued, within two (2) years after the date this development variance permit is issued.
- 8. The terms of this development variance permit or any amendment to it, are binding on all persons who acquire an interest in the Land.
- 9. This development variance permit is not a building permit.

AUTHORIZING RESOLUTION PASSED BY THE COUNCIL/DELEGATED OFFICIAL, THE DAY OF $\,$, 20 $\,$.

ISSUED THIS DAY OF , 20.

City Clerk – Jennifer Ficoce	

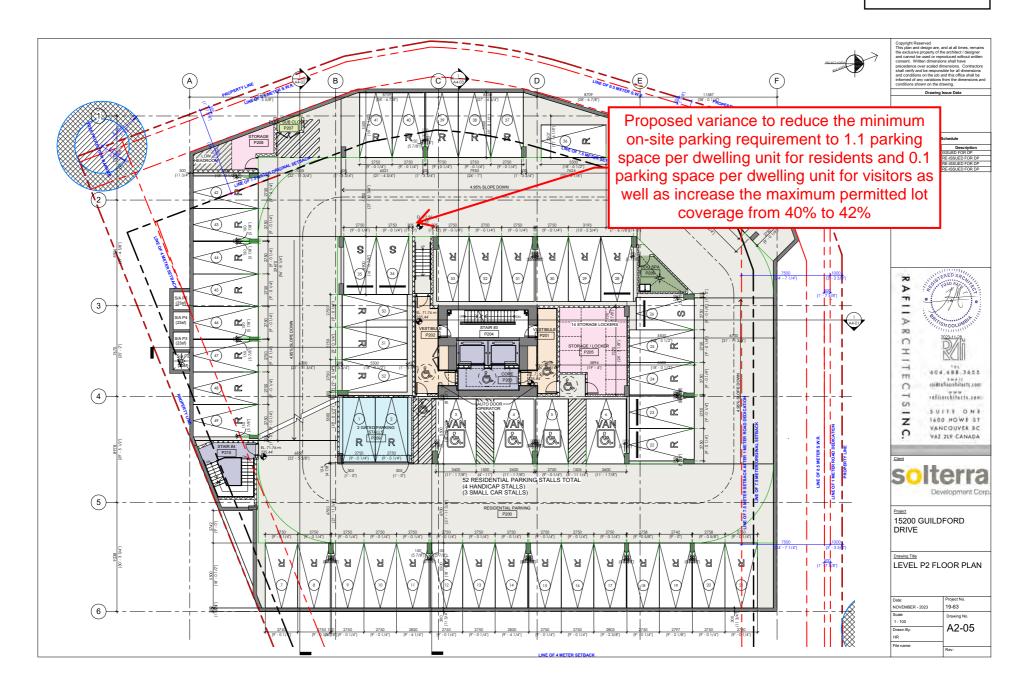



Advisory Design Panel Minutes

Appendix VI

Location: Virtual

THURSDAY, OCTOBER 26, 2023

Time: 3:00 p.m.

Present:

M. Cheung

M. Mitchell

Guests:

Panel Members: Emily Kearns, Ankenman Associates Architects Inc. G. Brumpton, Chair

Cam Woodruff, PMG Landscape Architects

Foad Raffii, Raffii Architects Inc Stephen Vincent, Durante Kreuk Ltd.

Rajinder Warraich, Flat Architecture Caelan Griffiths, PMG Landscape Architects

Y. Popovska B. Ransford

R. Salcido

J. Packer

Staff Present:

A. McLean, City Architect

V. Goldgrub, Urban Design Planner N. Chow, Urban Design Planner

A. Yahav, Clerk 3

2. 4:15 p.m.

> File No.: 7921-0153-00

New or Resubmit: New Last Submission Date: N/A

Description: Detailed Development Permit for one 20-storey apartment building

consisting of 175 dwelling units with underground parking.

15200 Guildford Drive (Guildford) Address:

Developer: Alex Putrenko, Solterra (Guildford 2) Development Corp

Foad Raffii, Raffii Architects Inc Architect: Landscape Architect: Stephen Vincent, Durante Kreuk Ltd.

Misty Jorgensen Planner: Urban Design Planner: Nathan Chow

The Urban Design Planner advised that staff generally support the project.

The Panel was asked to comment on the overall site planning, pedestrian and vehicular movement, architectural expression, overall landscape concept, and public realm interfaces.

The Project Architect presented an overview of the site planning, streetscapes, building concept, and 3D Views.

The Landscape Architect presented an overview of the general concept for the Landscape design.

ADVISORY DESIGN PANEL STATEMENT OF REVIEW

It was Moved by B. Ransford

Seconded by M. Cheung

That the Advisory Design Panel (ADP) SUPPORT

the project and recommends that the applicant address the following issues to the satisfaction of the Planning & Development Department.

Carried

Key Points

- Consider options to better integrate the three architectural elements of the project -podium, tower and off-set balconies. Current design is per city staff direction and we are in agreement with it. Nevertheless, the architectural details will be further refined.
- Reconsider some design elements on the façade, such as the overall white
 colour and varied glazing colours. Current design is per city staff direction and
 we are in agreement with it. Nevertheless, the architectural details will be
 further refined.
- Consider options to mitigate effects of overlook and other privacy concerns with the adjacent buildings. Planter and hedging to be added on rooftop deck, privacy / obscure glass in TH bedrooms' widows. Privacy fence to be added along sidewalk across neighbouring property.
- Consider reorganizing the loading ramp for optimal functionality. We agree with this comment and will address this item with the following:
 - Transformation of the loading bay entrance into a more aesthetic and functional second building entrance
 - o Addition of pedestrian pathway with decorative paving
 - o Addition of a drop-off / pick-up area for deliveries
- Consider options to mitigate noise and smell (pet area) in the amenity areas.
 Current design is optimal, that being said, further mitigation features will be explored.
- Reconsider the use of gas as an energy source. Controls (timers, etc) to be added to outdoor fireplace to improve energy use efficiency.

Site

- Consider relocating the amenity areas from street frontage to southern side to provide more comfortable and usable areas. Current design is most optimal.
- Consider other possible location options for the kids' play area, currently located on the second-floor podium, to account for any safety concerns.
 Presently the kid's play area is located on the main floor of the podium; the area

is single entry from inside the proposed development. While the proposed fencing meets code requirements, a higher fence will be specified.

- Consider instituting a more official lobby entry and pedestrian circulation route that is separate from the loading bay. Concern addressed within loading bay concerns section.
- Consider reviewing the pick-up and drop-off loading areas to ensure parking is sufficient for deliveries, mail, and Uber pickup. Concern addressed within loading bay concerns section.
- Consider conducting a new traffic impact study to ensure the outcome of all new conditions. A traffic study has been conducted during the rezoning process. Most recently, another review was conducted, a memo from which indicates that the additional traffic flow from the proposed development will not trigger (per city threshold) the need to conduct a TIA. The memo has been provided to city staff.
- Reconsider the volume of the parkade to reduce the number of levels. Due to subsequent MOTI comments regarding setting the current proposed parkade outline inwards by 3m, it will not be possible to decrease the volume of the parkade while maintaining the minimum prescribed parking stall count.

Form and Character

- Consider incorporating some elements within the façade to connect the three buildings elements vertically and to unify them. Architectural details will be further refined.
- Reconsider the articulation of the townhouse exterior column. Architectural
 details will be further refined via addition of planters within townhouse terraces
 and adjusting column form.
- Consider implementing further privacy measures at the front entry near the townhouse. The item is to be address be the addition of hedges to be between townhome patios, as well as areas fronting sidewalk.
- Consider incorporating an accent colour or texture to the façade to serve as an
 identifiable landmark on the approach to the intersection. Current design is per
 city staff direction and we are in agreement with it. Nevertheless, the
 architectural details will be further refined.
- Reconsider the white painted concrete. Current design is per city staff direction and we are in agreement with it. Nevertheless, the architectural details will be further refined.
- Reconsider the varied colours of the glass elements. We will ensure to standardize colours and ensure rendering representation is accurate and consistent.

• Consider using brick for the townhouse cladding. Current design is per city staff direction and we are in agreement with it. Nevertheless, the architectural details will be further refined.

Landscape

- Consider reviewing supplementary berming or noise mitigation on the property line periphery to reduce noise and traffic. Current design is efficient; in order to further mitigate the noise and lights pollution, additional, larger trees will be added within the North West corner in order to mitigate noise and light cause from street traffic.
- Consider additional tree planting at the dog area and at the golf putting green
 to provide a substantial buffer. Current design is efficient; in order to further
 mitigate the noise and lights pollution, additional, larger trees will be added
 within the North West corner in order to mitigate noise and light cause from
 street traffic.
- Recommend reviewing traffic headlights and screening for residential areas at
 intersection. Current design is efficient; in order to further mitigate the noise
 and lights pollution, additional, larger trees will be added within the North
 West corner in order to mitigate noise and light cause from street traffic.
- Consider providing additional buffer between neighbouring buildings and the
 walkway on south. A fence along the walkway is to be added; additional
 planting to be considered. Note that the pathway design has been created at
 request of neighbouring property.
- Consider supplementary planting and screening between the rooftop patios and the neighbouring existing buildings to reduce overlook and mitigate privacy issues. Current landscape drawing call for hedges and screening between rooftop patios to mitigate piracy issues; additional hedges are to added between townhome rooftops and townhome entry terraces.
- Consider the addition of seating pods in the outdoor kitchen area to provide more space for small groups and individuals. Bar top tables and stools to be added in outdoor area.
- Consider the addition of a barbecue in the outdoor kitchen area, and similarly, a counter tops and functional cooking spaces. BBQ located in outdoor kitchen area is already present on provided ADP drawing set.
- Recommend relocating the bike racks to an area in a closer line of sight. Alternate location for bike racks to be considered.
- Ensure effective diversity in tree and shrub species for 4 season interest and optimum wildlife habitat. Current design is in in line with the outlined requirements. The addition of large, coniferous trees at North West corner will further address this concern.

• Ensure all trees have adequate soil volume and depth. Current design is already per outlined requirements.

CPTED

No specific issues were identified. Noted

Sustainability

- Consider the location of HRVs and heat pumps, accounting for enough physical space to benefit from higher efficiency, lower noise, better filtration, and (critically) summer bypass. Comments noted; our mechanical engineer has confirmed that the VRF system must remain in the lower level location in order to meet capacity requirements.
- Consider electrification of the hot water system. Current system meets city bylaws
- Consider alternatives to gas for the outdoor fireplace. Current system meets city bylaws, a timer will be added to reduce consumption
- Consider moving air intakes away from the busy street, including the parkade.
 Air intakes will be moved away from 152nd street and relocated to South East of site
- Consider options to ensure safe entry and exit from the bike maintenance room. In order to address this comment, a pony wall will be added on the exterior of the bike maintenance room in order to increase safety of entry and protect from exterior elements.
- Recommend providing both internal and exterior E-bike parking. To be considered.
- Consider details of the central recycling room to encourage proper disposal of waste, such as being well-lit, having sorting tables, and having pictograms to address language barriers. Noted
- Consider alternatives to turf grass. Current design is optimal as turf grass will be used for putting green and portion of dog off-leash park, areas with uses where this surface is put to best use. Artificial turf grass is low maintenance and requires little to no inputs, making it a sustainable solution in some situations. Areas where turf grass is specified are shady high traffic areas. Attempting to maintain live turf in these areas would not be sustainable.
- Consider stormwater management. To be considered.
- Consider implementing a car wash system that recycles water. To be considered.

Accessibility

• Consider options to create barrier-free access to all areas on the ground floor, dog park, kids' play area, and outdoor amenity spaces, especially to areas only accessed with steps. The current design provides barrier-free access to all amenity areas from within the core. The secondary entrance (loading bay) also includes a lift.

H. BYLAWS AND PERMITS

PERMITS - APPROVALS

5. Planning Report – Application No. 7921-0153-00 15200 Guildford Drive

Owner: Solterra Development (Guildford) Corp. (Director Information: G. Nichele) Agent: Solterra Development (Guildford) Corp. (Kevin Yang)

Development Variance Permit No. 7921-0153-00

To reduce the minimum on-site parking requirement for non-ground oriented multiple unit residential dwellings to 1.1 parking space per dwelling unit for residents and 0.2 parking space per dwelling unit for visitors; and to vary the maximum permitted lot coverage from 40% to 42% in order to permit the construction of a 20-storey mid-rise apartment building consisting of 175 dwelling units in Guildford.

Supported by Council December 18, 2023

It was Moved by Councillor Annis

Seconded by Councillor Bose

That Council authorize the issuance of

Development Variance Permit No. 7921-0153-00.

RES.R24-455

Carried

Development Permit No. 7921-0153-00 15200 Guildford Drive To issue Development Permit for Form and Character.

Council authorized to draft December 4, 2023

It was Moved by Councillor Kooner

Seconded by Councillor Bains

That Council authorize the issuance of

Development Permit No. 7921-0153-00.

RES.R24-456 <u>Carried</u>

H. BYLAWS AND PERMITS

PERMITS

15. Development Variance Permit No. 7921-0153-00

Owner: Solterra Development (Guildford) Corp. (Director Information: G. Nichele) Agent: Solterra Development (Guildford) Corp. (Alex Putrenko) 15200 Guildford Drive

To reduce the minimum on-site parking requirement for non-ground oriented multiple unit residential dwellings to 1.1 parking space per dwelling unit for residents and 0.2 parking space per dwelling unit for visitors; and to vary the maximum permitted lot coverage from 40% to 42% in order to permit the construction of a 20-storey mid-rise apartment building consisting of 175 dwelling units in Guildford.

Thirteen pieces of correspondence expressing support, three pieces of correspondence expressing opposition, and four pieces of correspondence expressing concerns were received for this proposal.

It was Moved by Councillor Annis

Seconded by Councillor Bose

That Council support Development Variance

Permit No. 7921-0153-00, and consider issuance of the Permit upon final approval of the associated Development Permit.

RES.R23-2606 <u>Carried</u>

B. LAND USE APPLICATIONS

13. 7921-0153-00

15200 Guildford Drive

Owner: Solterra Development (Guildford) Corp.

Director Information: G. Nichele

Officer Information as at December 20, 2022: G. Nichele (President, Secretary)

Agent: Solterra Development (Guildford) Corp. (Alex Putrenko)

Development Permit / Development Variance Permit

to permit the construction of a 20-storey mid-rise apartment building consisting of 175 dwelling units in Guildford. A variance is proposed to reduce the minimum on-site parking requirement and to increase the permitted lot coverage under the CD Zone.

It was

Moved by Councillor Bains Seconded by Councillor Kooner That:

- 1. Council authorize staff to draft Development Permit No. 7921-0153-00 generally in accordance with the attached drawings (Appendix I).
- 2. Council approve Development Variance Permit No. 7921-0153-00, varying the following, to proceed to Public Notification:
 - (a) to reduce the minimum on-site parking requirement for non-ground oriented multiple unit residential dwellings to 1.1 parking space per dwelling unit for residents and 0.1 parking space per dwelling unit for visitors; and
 - (b) to vary the maximum permitted lot coverage under CD Bylaw No. 17032 from 40% to 42%.
- 3. Council instruct staff to resolve the following issues prior to final approval:
 - (a) ensure that all engineering requirements and issues including restrictive covenants, dedications, and rights-of-way where necessary, are addressed to the satisfaction of the General Manager, Engineering;
 - (b) approval and input from the Ministry of Transportation & Infrastructure;
 - (c) resolution of all urban design issues to the satisfaction of the Planning and Development Department;
 - (d) submission of a finalized landscaping plan and landscaping cost estimate to the specifications and satisfaction of the Planning and Development Department;
 - (e) submission of a finalized tree survey and a statement regarding tree preservation to the satisfaction of the City Landscape Architect;

- (f) the applicant satisfy the deficiency in tree replacement on the site, to the satisfaction of the Planning and Development Department;
- (g) discharge the Restrictive Covenant (No Build) registered on title (CA2287218); and
- (h) submission of an acoustical report for the units adjacent to 152 Street and registration of a Section 219 Restrictive Covenant to ensure implementation of noise mitigation measures.

Before the vote was taken:

A friendly amendment to recommendation 2. (a) of Development Variance Permit No. 7921-0153-00 was accepted unanimously. The amendment 2. (a) is as follows:

Delete

"o.1 parking space per dwelling unit for visitors"

Insert

"o.2 parking space per dwelling unit for visitors"

The vote was then taken on the main motion, as amended.

RES.R23-2411

main motion, as amended, Carried